DRAWN BY:

CHECKED BY:

09/05/2025 AS SHOWN

E EXISTING CONDITIONS PLAN
ONSON COURT SITE UPGRADE P
CHESTER HOUSING AUTHORITY

PROJECT NO: 2285-054

HORIZONTAL/VERTICAL DATUM NOTE:

—— о/н ——

VERTICAL CONTROL IS REFERENCED TO THE NORTH AMERICAN VERTICAL DATUM OF 1988 (NAVD 88/GEOID 12A).

OVERHEAD UTILITY LINES

DECIDUOUS TREE

CONIFEROUS TREE

HORIZONTAL CONTROL IS REFERENCED TO THE NORTH AMERICAN DATUM OF 1983 (NAD 83/NA 2011).


### UNDERGROUND UTILITIES NOTE:

UNDERGROUND UTILITIES SHOWN WERE MAPPED USING A COMBINATION OF FIELD LOCATED EVIDENCE AND EXISTING UTILITY MAPS. THE ACCURACY OF THESE UTILITY LOCATIONS CANNOT BE GUARANTEED. ALL UNDERGROUND UTILITIES SHOULD BE FIELD VERIFIED BEFORE EXCAVATING. CALL 'DIG SAFELY NEW YORK' 1-800-962-7962.

### GENERAL NOTE:

ALL PLANTINGS INSTALLED IN PHASE 2 ARE NOT SHOWN ON THIS TOPOGRAPHIC SURVEY. SOME PLANTINGS INSTALLED DURING PHASE 2 WITHIN THE PHASE 3 SCOPE AREAS MAY NOT BE EXACT LOCATIONS AND SHOULD BE CONSIDERED APPROXIMATE.

SURVEY CONTROL POINT TABLE									
POINT NO.	NORTHING	EASTING	ELEVATION	DESCRIPTION					
1	1147984.8570	1404129,8370	523.56	CP-PK					
742	1148053.4710	1404133.2400	526.31	CP-N					
2000	1148020.0290	1404322.8780	523.50	CP-PK					
2001	1148134.8080	1404319.9410	524.65	CP-PK					
2002	1148253.5180	1404313.6980	525.59	CP-PK					
5000	1148148.2880	1404424.7400	525.27	CP N					
5001	1148137.9000	1404198.3410	527.85	CP N					

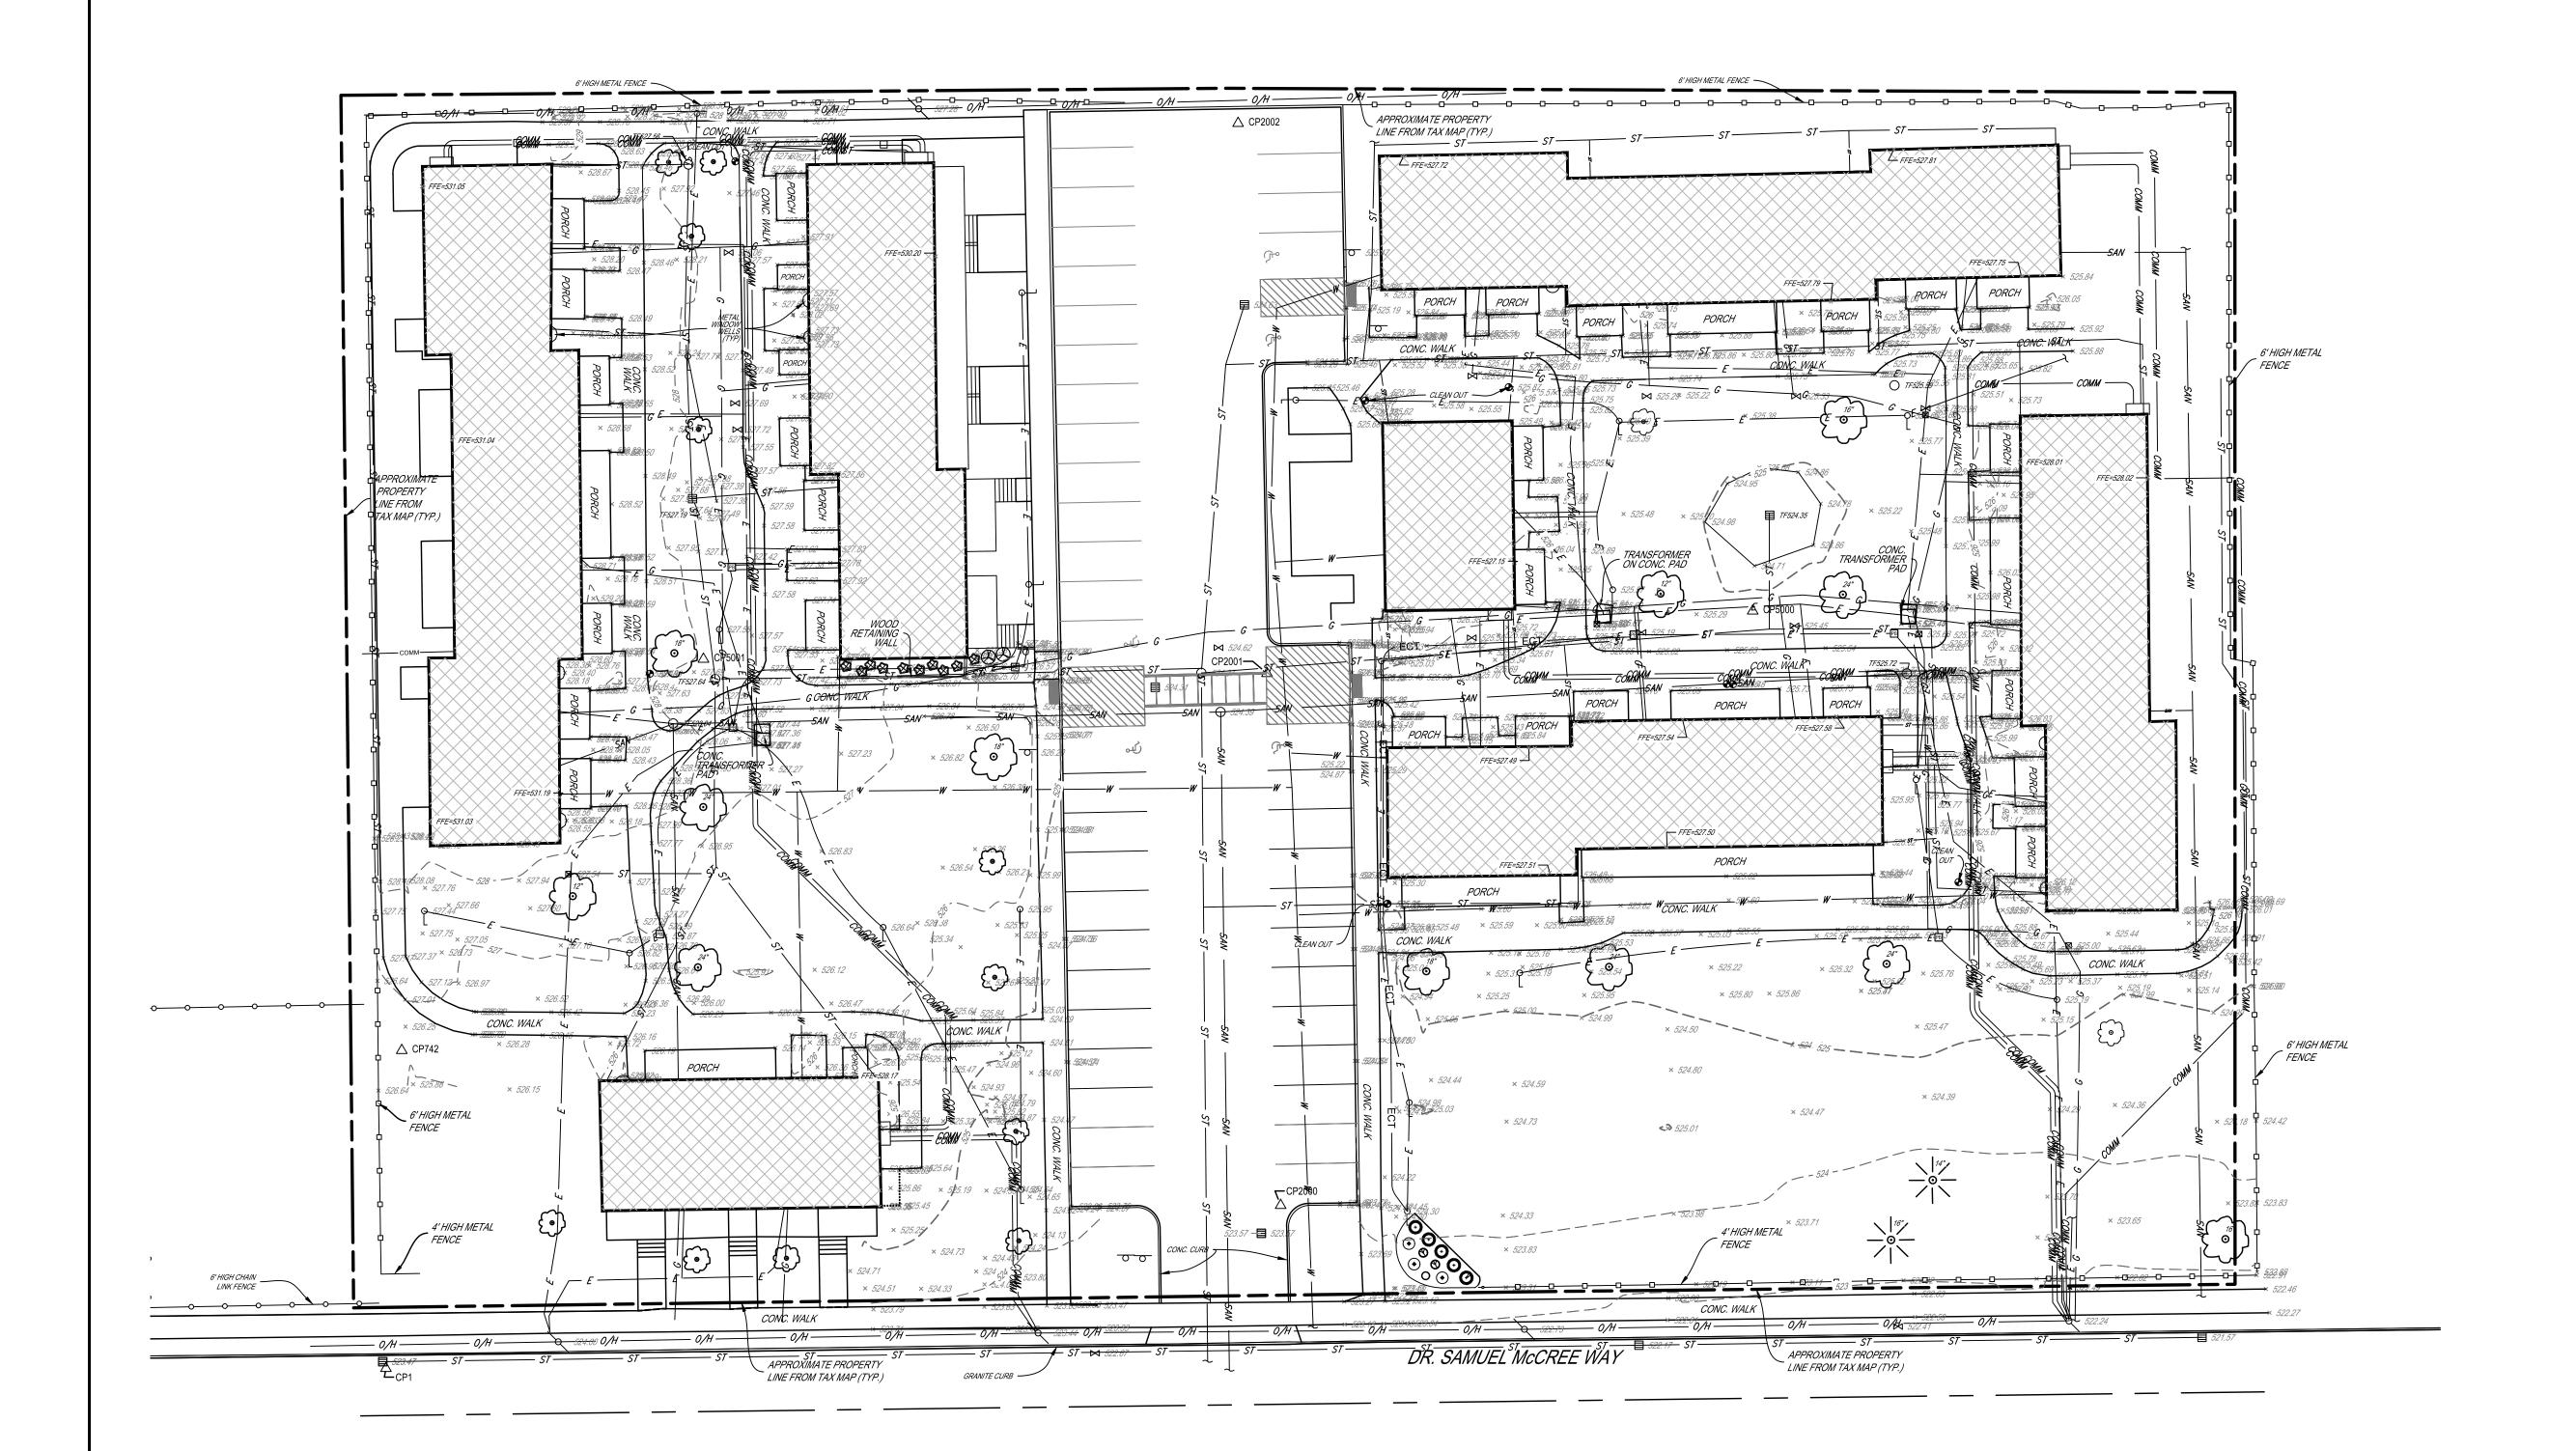



SCALE: 1" = 20'

→ SITE EXISTING CONDITIONS PLAN

**GENERAL SITE NOTES**:

1. LOCATIONS, SIZES, AND DEPTHS OF SUBSURFACE UTILITIES ARE BASED ON OUTDATED BLUEPRINTS FROM 1967 AND FIELD SURVEY DATA FROM 2022. SOME UTILITIES HAVE BEEN LOCATED BY A SUBCONSULTANT GPRS UTILITY FINDINGS MAP, DATED 10/05/23. CONTRACTOR TO LOCATE ALL UNDERGROUND UTILITIES PRIOR TO THE START OF WORK. CONTRACTOR IS RESPONSIBLE FOR ANY DAMAGE TO EXISTING UTILITIES NOT OUTLINED IN THE SCOPE OF WORK.

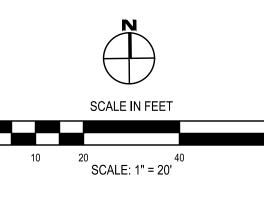

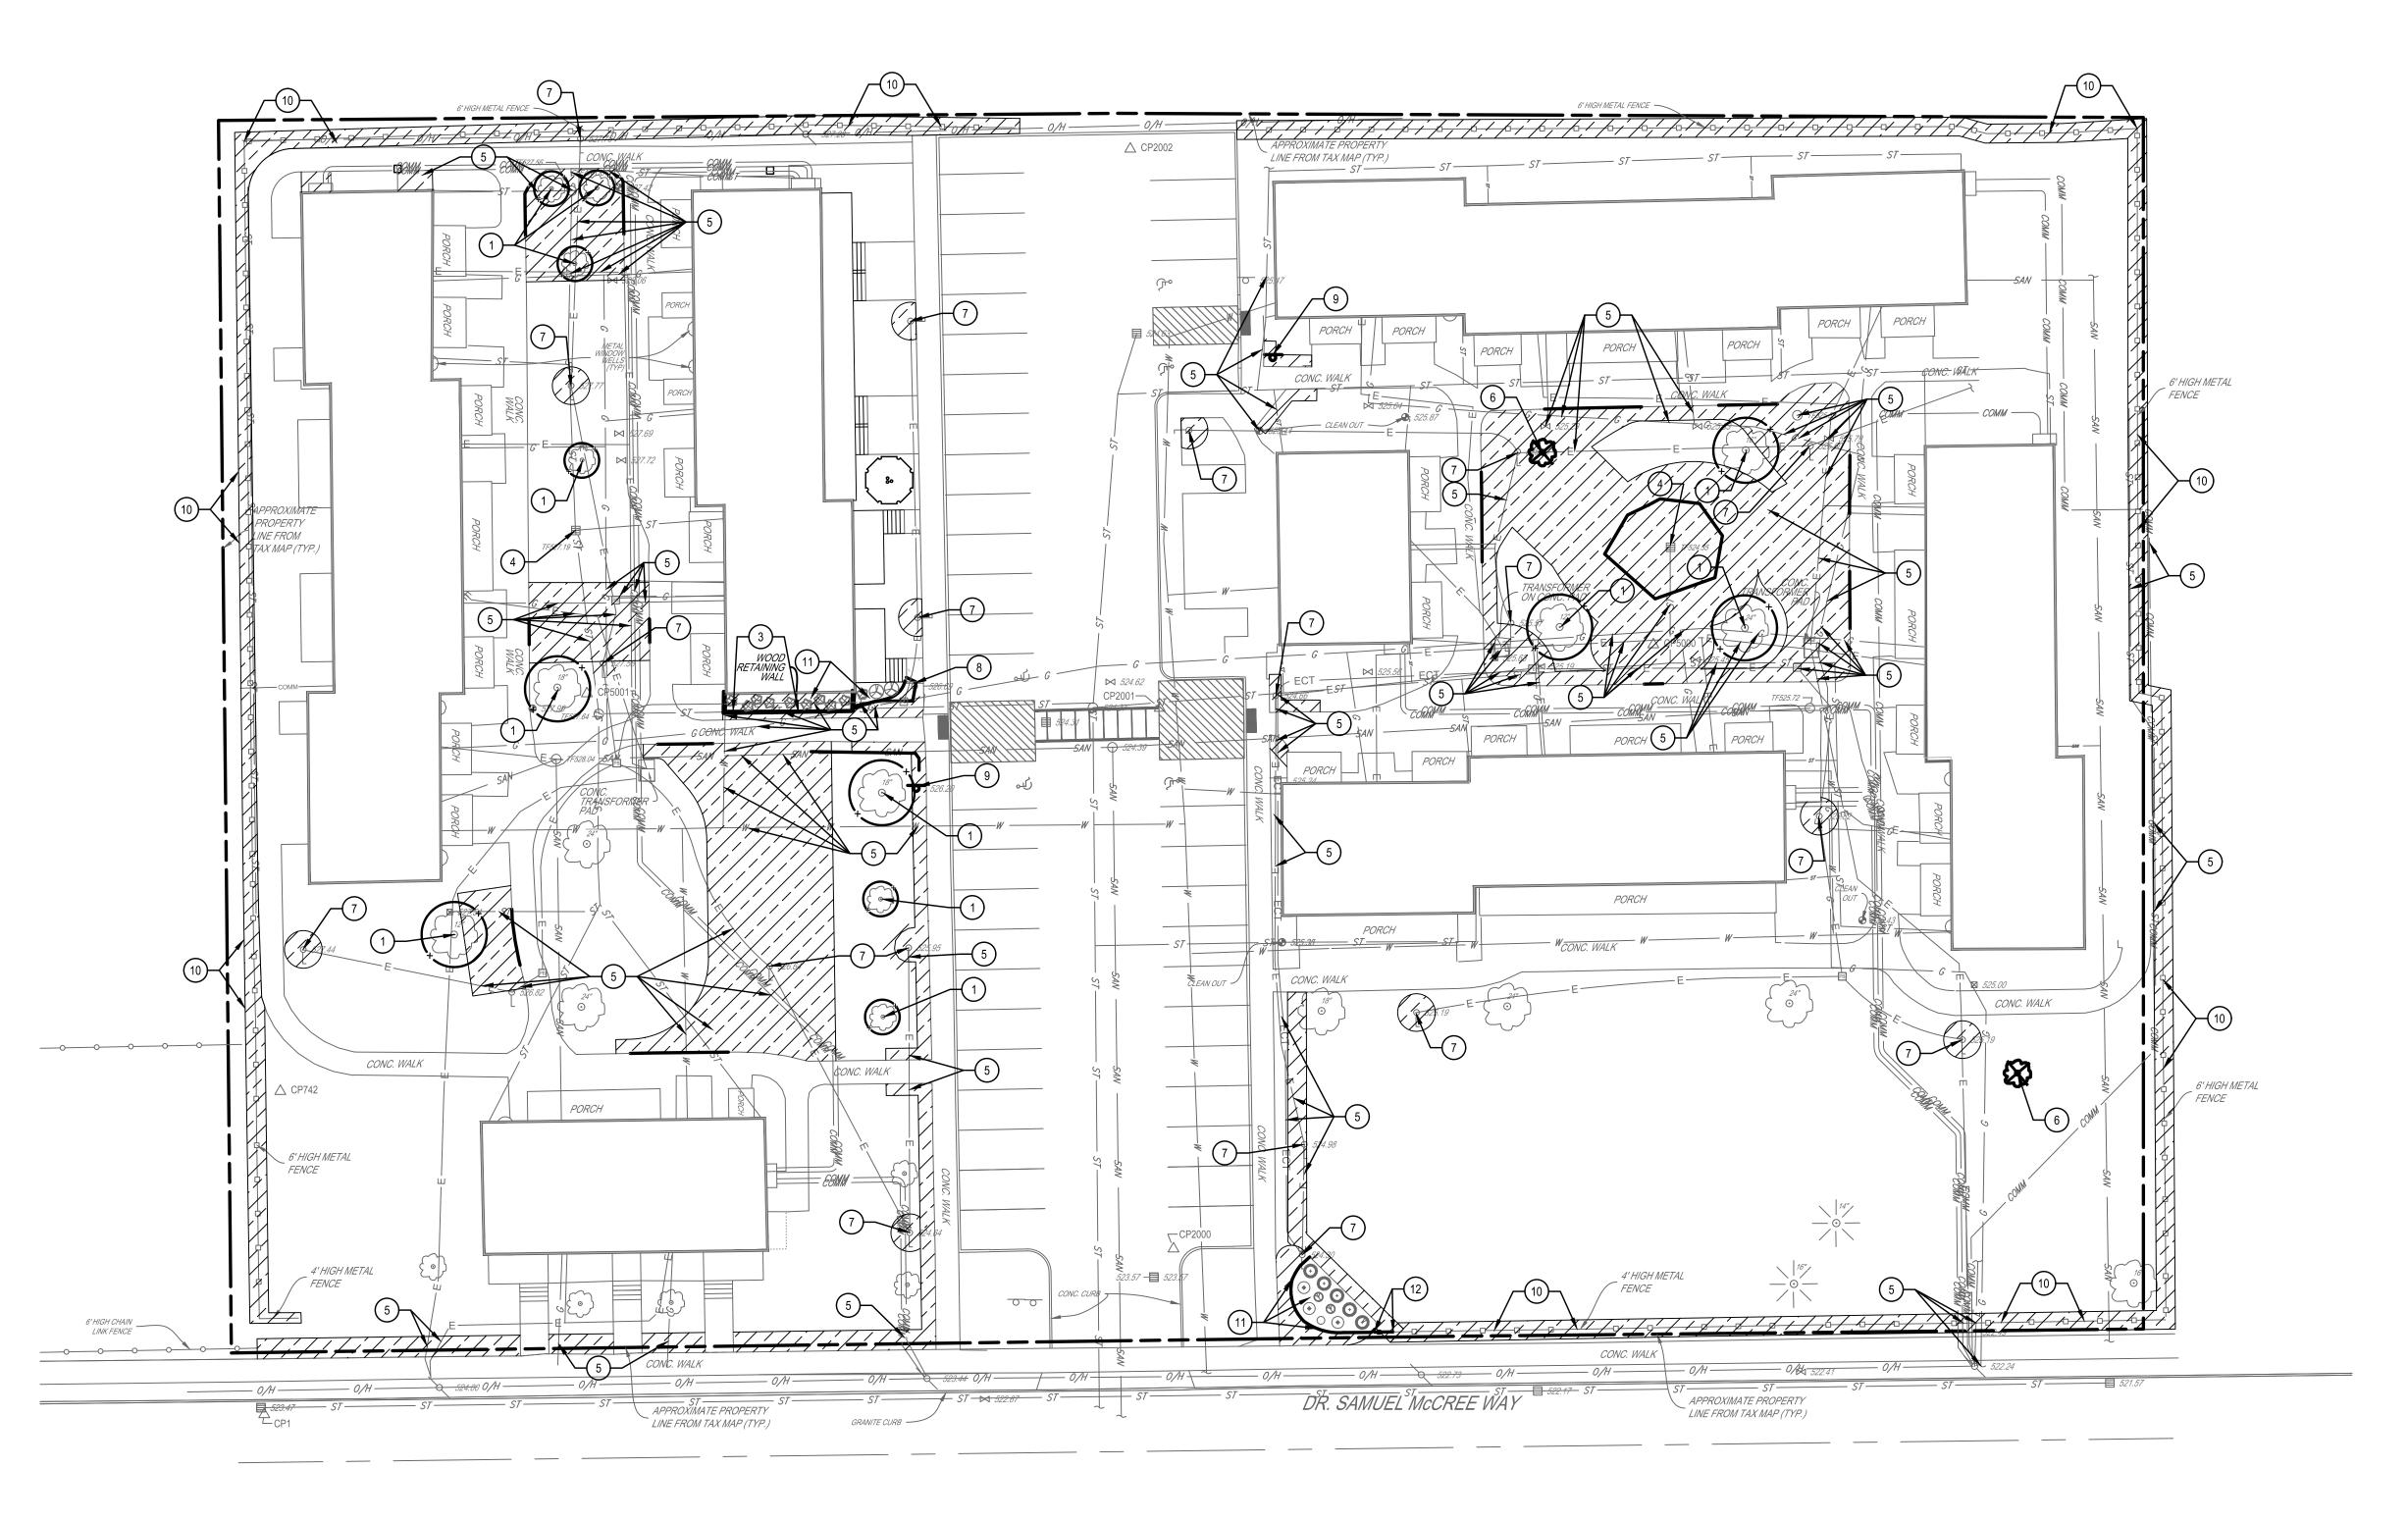

SCALE: 1" = 20'

GENERAL DEMOLITION NOTES:

- A. LOCATIONS, SIZES, AND DEPTHS OF SUBSURFACE UTILITIES ARE BASED ON OUTDATED BLUEPRINTS FROM 1967. CONTRACTOR TO LOCATE ALL UNDERGROUND UTILITIES PRIOR TO THE START OF WORK. CONTRACTOR IS RESPONSIBLE FOR ANY DAMAGE TO
- EXISTING UTILITIES NOT OUTLINED IN THE SCOPE OF WORK. B. SEE SPECIFICATIONS, GENERAL NOTES FOR ADDITIONAL INFORMATION.
- C. COORDINATE DEMOLITION WITH ALL OTHER DEMO SHEETS WITHIN THIS SET. PROVIDE ALL DEMOLITION INCIDENTAL TO OR REQUIRED FOR NEW CONSTRUCTION WHETHER OR NOT IT IS SPECIFICALLY NOTED.
- D. ALL UTILITY REMOVAL, RELOCATION, CUTTING, CAPPING AND/OR ABANDONMENT SHALL BE COORDINATED WITH THE APPROPRIATE UTILITY PROVIDER. CONTRACTOR SHALL NOTIFY ALL ADJACENT PROPERTIES OF UTILITY INTERRUPTION AT LEAST THREE (3) DAYS IN ADVANCE OF SCHEDULED WORK.
- E. LIMIT DISTURBANCE WHERE POSSIBLE. PROTECT ALL EXISTING IMPROVEMENTS TO REMAIN AND REPAIR BACK TO ORIGINAL CONDITION AT CONTRACTOR'S EXPENSE IF DAMAGE OCCURS RESULTANT FROM CONTRACTOR'S OPERATIONS OR NEGLIGENCE.
- F. KEEP ADJACENT SURFACES CLEAR OF CONSTRUCTION EQUIPMENT AND DEBRIS AT ALL TIMES. PROVIDE TRAFFIC CONTROL MEASURES AS NEEDED FOR PUBLIC SAFETY. G. EROSION AND SEDIMENTATION CONTROL MEASURES AROUND

AREAS OF DEMOLITION SHALL BE INSTALLED PRIOR TO BEGINNING DEMOLITION. UTILIZE INLET PROTECTION AT ALL

STORM INLET STRUCTURES. SEE DRAWING C4.1. H. CONTRACTOR SHALL FOLLOW THE CITY OF ROCHESTER TRAFFIC CONTROL GUIDELINES.

SITE DEMOLITION NOTES:

- 1. PROTECT EXISTING TREES TO REMAIN, TYP. SEE TREE PROTECTION DETAIL 6/C6.1. PROTECT PLANTING BED AREA FOR NEWLY PLANTED TREES.
- 2. PROTECT EXISTING ADJACENT SIDEWALK TO REMAIN.
- 3. REMOVE TIMBER WOOD RETAINING WALL AND BLACK LANDSCAPING BED EDGE. PREPARE SUBGRADE FOR NEW PLANTINGS, TYP. SEE GRADING PLAN FOR ELEVATIONS. LEGALLY AND PROPERLY DISPOSE OF MATERIALS, RECYCLING MATERIALS WHERE POSSIBLE.
- 4. PROTECT EXISTING CATCH BASINS TO REMAIN, TYP. ADJUST RIM TO NEW GRADE ELEVATION. SEE SITE GRADING AND UTILITY
- 5. PROTECT EXISTING UTILITIES (PIPE AND/OR STRUCTURE) TO REMAIN, TYP.
- 6. TRANSPORT EXISTING TREE USING MECHANICAL SPADE AS SPECIFIED. FOR TREE IN THE NORTHERN COURTYARD, HAND DIG THE EXISTING ELECTRIC SERVICE TO CONFIRM ITS LOCATION BEFORE REMOVING TREE. REPLANT AT LOCATIONS INDICATED ON THE SITE LANDSCAPING PLANS (CONFIRM FINAL LOCATION WITH OWNER BEFORE TRANSPLANTING).
- 7. PROTECT EXISTING LIGHT POLE TO REMAIN. 8. PROTECT EXISTING SIGN TO REMAIN.
- 9. REMOVE EXISTING SIGN, POST, AND CONCRETE BASE (IF
- APPLICABLE. SALVAGE SIGN FOR REUSE. 10. PROTECT EXISTING DECORATIVE FENCE TO REMAIN.
- 11. PROTECT EXISTING PLANTING BED AND PLANTS TO REMAIN. 12. REMOVE DECORATIVE FENCE TO LIMITS SHOWN.

DEMOLITION LEGEND

REMOVE VEGETATION OR LAWN/GRASS AND PREPARE SUBGRADE, TYP.

-SEE NOTES, SPECIFICATIONS. TREE PROTECTION FENCING, TYP.

DRAWN BY:

CHECKED BY:

09/05/2025

AS SHOWN

SITE DEMOLITION PLAN
BRONSON COURT SITE I
ROCHESTER HOUSING AU

PROJECT NO: 2285-054

SITE IMPROVEMENT PLAN - WEST

SCALE: 1" = 10'

LEGEND:

CONCRETE SIDEWALK 

----- EXPANSION JOINT

PICNIC TABLE

12' x 12' PERGOLA

FENCE LINE

EXISTING LIGHT POLE BASE

### GENERAL SITE NOTES:

- 1. SEE SITE LANDSCAPING PLANS FOR ALL PROPOSED PLANTINGS (NOT
- 2. LOCATIONS, SIZES, AND DEPTHS OF SUBSURFACE UTILITIES ARE BASED ON OUTDATED BLUEPRINTS FROM 1967. CONTRACTOR TO LOCATE ALL UNDERGROUND UTILITIES PRIOR TO THE START OF WORK. CONTRACTOR IS RESPONSIBLE FOR ANY DAMAGE TO EXISTING UTILITIES NOT OUTLINED IN THE SCOPE OF WORK.

- # SITE IMPROVEMENT NOTES:

  1. PROVIDE 5 INCH THICK CONCRETE SIDEWALK AND SUBBASE. SEE DETAIL 1 /
- 2. PROVIDE CONCRETE PAD AND SUBBASE. SEE DETAIL 2 / C6.1.
- 3. PROVIDE 4 FEET HIGH ORNAMENTAL ALUMINUM FENCE WITH CONCRETE FOOTINGS. SEE SPECIFICATIONS. MATCH EXISTING CONDITIONS FOR FENCE STYLE AND TYPE. REUSE SALVAGED FENCE SECTIONS FROM PHASE 2 CONSTRUCTION AND OWNER.
- 4. PROVIDE LIGHT POLE AND FIXTURE ON EXISTING CONCRETE LIGHT POLE BASE AT MOUNTING HEIGHTS INDICATED. SEE LIGHTING SCHEDULE THIS SHEET AND
- 5. PROVIDE SALVAGED ACCESSIBLE SPACE SIGNAGE AND POST. SEE DETAIL 7 /
- 6. PROVIDE 12 FEET BY 12 FEET SQUARE METAL SHADE STRUCTURE BY CREATIVE RECREATIONAL SYSTEMS, INC. (OR APPROVED EQUAL). SEE SPECIFICATIONS.
- 7. PROVIDE PICNIC TABLE AS SPECIFIED. SEE SPECIFICATIONS.

8. PROVIDE GRILL AS SPECIFIED. MOUNT TO PROPOSED CONCRETE PAD / WALK

- PER MANUFACTURER'S REQUIREMENTS. SEE SPECIFICIATIONS.
- 9. PROVIDE BENCH AS SPECIFIED. SEE SPECIFICATIONS. 10. PROVIDE EXTERIOR CHAIR AS SPECIFIED. SEE SPECIFICATIONS.
- 11. PROPOSED DECORATIVE FENCE END POST SHALL BE IMMEDIATELY ADJACENT TO CHAIN LINK FENCE POST. MAXIMUM GAP BETWEEN POSTS SHALL BE 3
- 12. PROVIDE MAIN ENTRANCE SIGN WITH BRICK PILLARS AND FOUNDATIONS. SEE DETAIL 9 / C6.1. SIGN FOUNDATIONS TO BE DESIGNED BY SIGN MANUFACTURER / PROVIDER. CITY ZONING SIGNAGE REQUIREMENTS SHALL BE MET WITH NEW SIGN. DETERMINATION WILL BE MADE IF ANY VARIANCES OR SPECIAL SITE PLAN APPROVALS ARE REQUIRED. SIGN MUST NOT BE MANUFACTURED OR INSTALLED UNTIL ARCHITECT HAS CONFIRMED A CERTIFICATE OF ZONING COMPLIANCE OR OTHER REQUIRED APPROVALS HAVE BEEN OBTAINED. CONTRACTOR TO CONFIRM WITH ARCHITECT PRIOR TO ANY
- 13. PROVIDE GARBAGE BIN AS SPECIFIED. SEE SPECIFICATIONS.


SCOPE BEING INITIATED.

- 14. FOR FENCE POST NEAR PORCH CORNER, HAND DIG TO LOCATE EXISTING 18 INCH CONCRETE FOOTING AND PLACE FENCE POST CONCRETE BASE AS CLOSE AS POSSIBLE TO THE EXISTING BASE WITHOUT DISTURBING IT.
- 15. HAND DIG TO LOCATE EXISTING UTILITY LOCATIONS IN VICINITY OF PROPOSED FENCE. CORRECT FENCE LOCATION BASED ON EXISTING CONDITIONS AND PER OWNER'S FINAL APPROVAL.

CITY OF ROCHESTER REGULATIONS

	SITE ZONING: R-1 / LOW DENSITY RESIDENTIAL		
	ZONING CODE	REQUIRED:	PROVIDED:
120-165	DUMPSTERS AND REFUSE COLLECTION AREAS		
	REFUSE COLLECTION CONTAINERS SHALL BE SCREENED FROM VIEW OF RESIDENCES AND/OR		
	PUBLIC STREET	YES	YES
120-167	FENCES AND WALLS		
	WITHIN RESIDENTIAL DISTRICTS NO FENCING IN A FRONT YARD SHALL EXCEED 4'-0" IN HEIGHT	≤4'-0" HEIGHT	4'-0" HEIGHT
	WITHIN RESIDENTIAL DISTRICTS NO FENCING SHALL BE MORE THAN 60% SOLID	≤60%	YES
120-169	LANDSCAPING, BUFFERS, SCREENING		
	5'-0" LANDSCAPE AREA SHALL BE REQUIRED ALONG PUBLIC STREETS AND SIDEWALKS.		
	SHRUBS QTY WITHIN LANDSCAPED AREAS WILL BE A MIN. 1 SHRUB PER 15' OF PERIMETER.		
	507 LF PERIMETER/ 15 = 33.8 = 34 SHRUBS	34 SHRUBS	37 SHRUBS
	TREE QTY WITHIN LANDSCAPED AREAS WILL BE A MIN. 1 TREE PER 40' OF PERIMETER.		
	507 PERIMETER/ 40 = 12.68 = 13 TREES - 11 EXISTING TREES = 2 NEW TREES	2 NEW TREES	2 TREES

IGHTING	SCHED!	<u>ULE</u>			T		1	1	I	I
Symbol	Label	Quantity	Manufacturer	Catalog Number	Description	Filename	Number Lamps	Lumens Per Lamp	Light Loss Factor	Wattage
	S5	7	Sternberg Lighting	SL660-12L40T5-MDL018- -CA	Medium size Post Top Mount fixture, T5, Clear Acrylic Flat	SL660-12L40T5- MDL018-CA.IES	1	5781	0.9	60.4
<b>^</b>	S2	3	Sternberg Lighting	SL660-12L40T2-MDL014- -CA	Medium size Post Top Mount fixture, T2, Clear Acrylic Flat	SL660-12L40T2- MDL014-CA.IES	1	4837	0.9	46.3
<b>^</b>	S2B	2	Sternberg Lighting	SL660-12L40T2-MDL014- -CA-BLOC	Medium size Post Top Mount fixture, T2, Clear Acrylic Flat-Rear Light Blocking	SL660-12L40T2- MDL014-CA- BLOC.IES	1	3558	1	45.6
•	S4	5	Sternberg Lighting	SL660-12L40T4-MDL014- -CA	- Medium size Post Top Mount fixture, T4, Clear Acrylic Flat SL660-12L40T4-MDL014-CA.IES	SL660-12L40T4-	1	4660	1	46.1
•	S4B	3	Sternberg Lighting	SL660-12L40T4-MDL014- -CA-BLOC	Medium size Solana Arm Mount fixture, T4, CA - Rear Light Blocking	SL660-12L40T4- MDL014-CA- BLOC.IES	1	3027	1	45.6

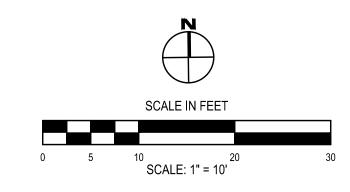


PROJECT NO: 2285-054

DRAWN BY: CHECKED BY:

09/05/2025

AS SHOWN

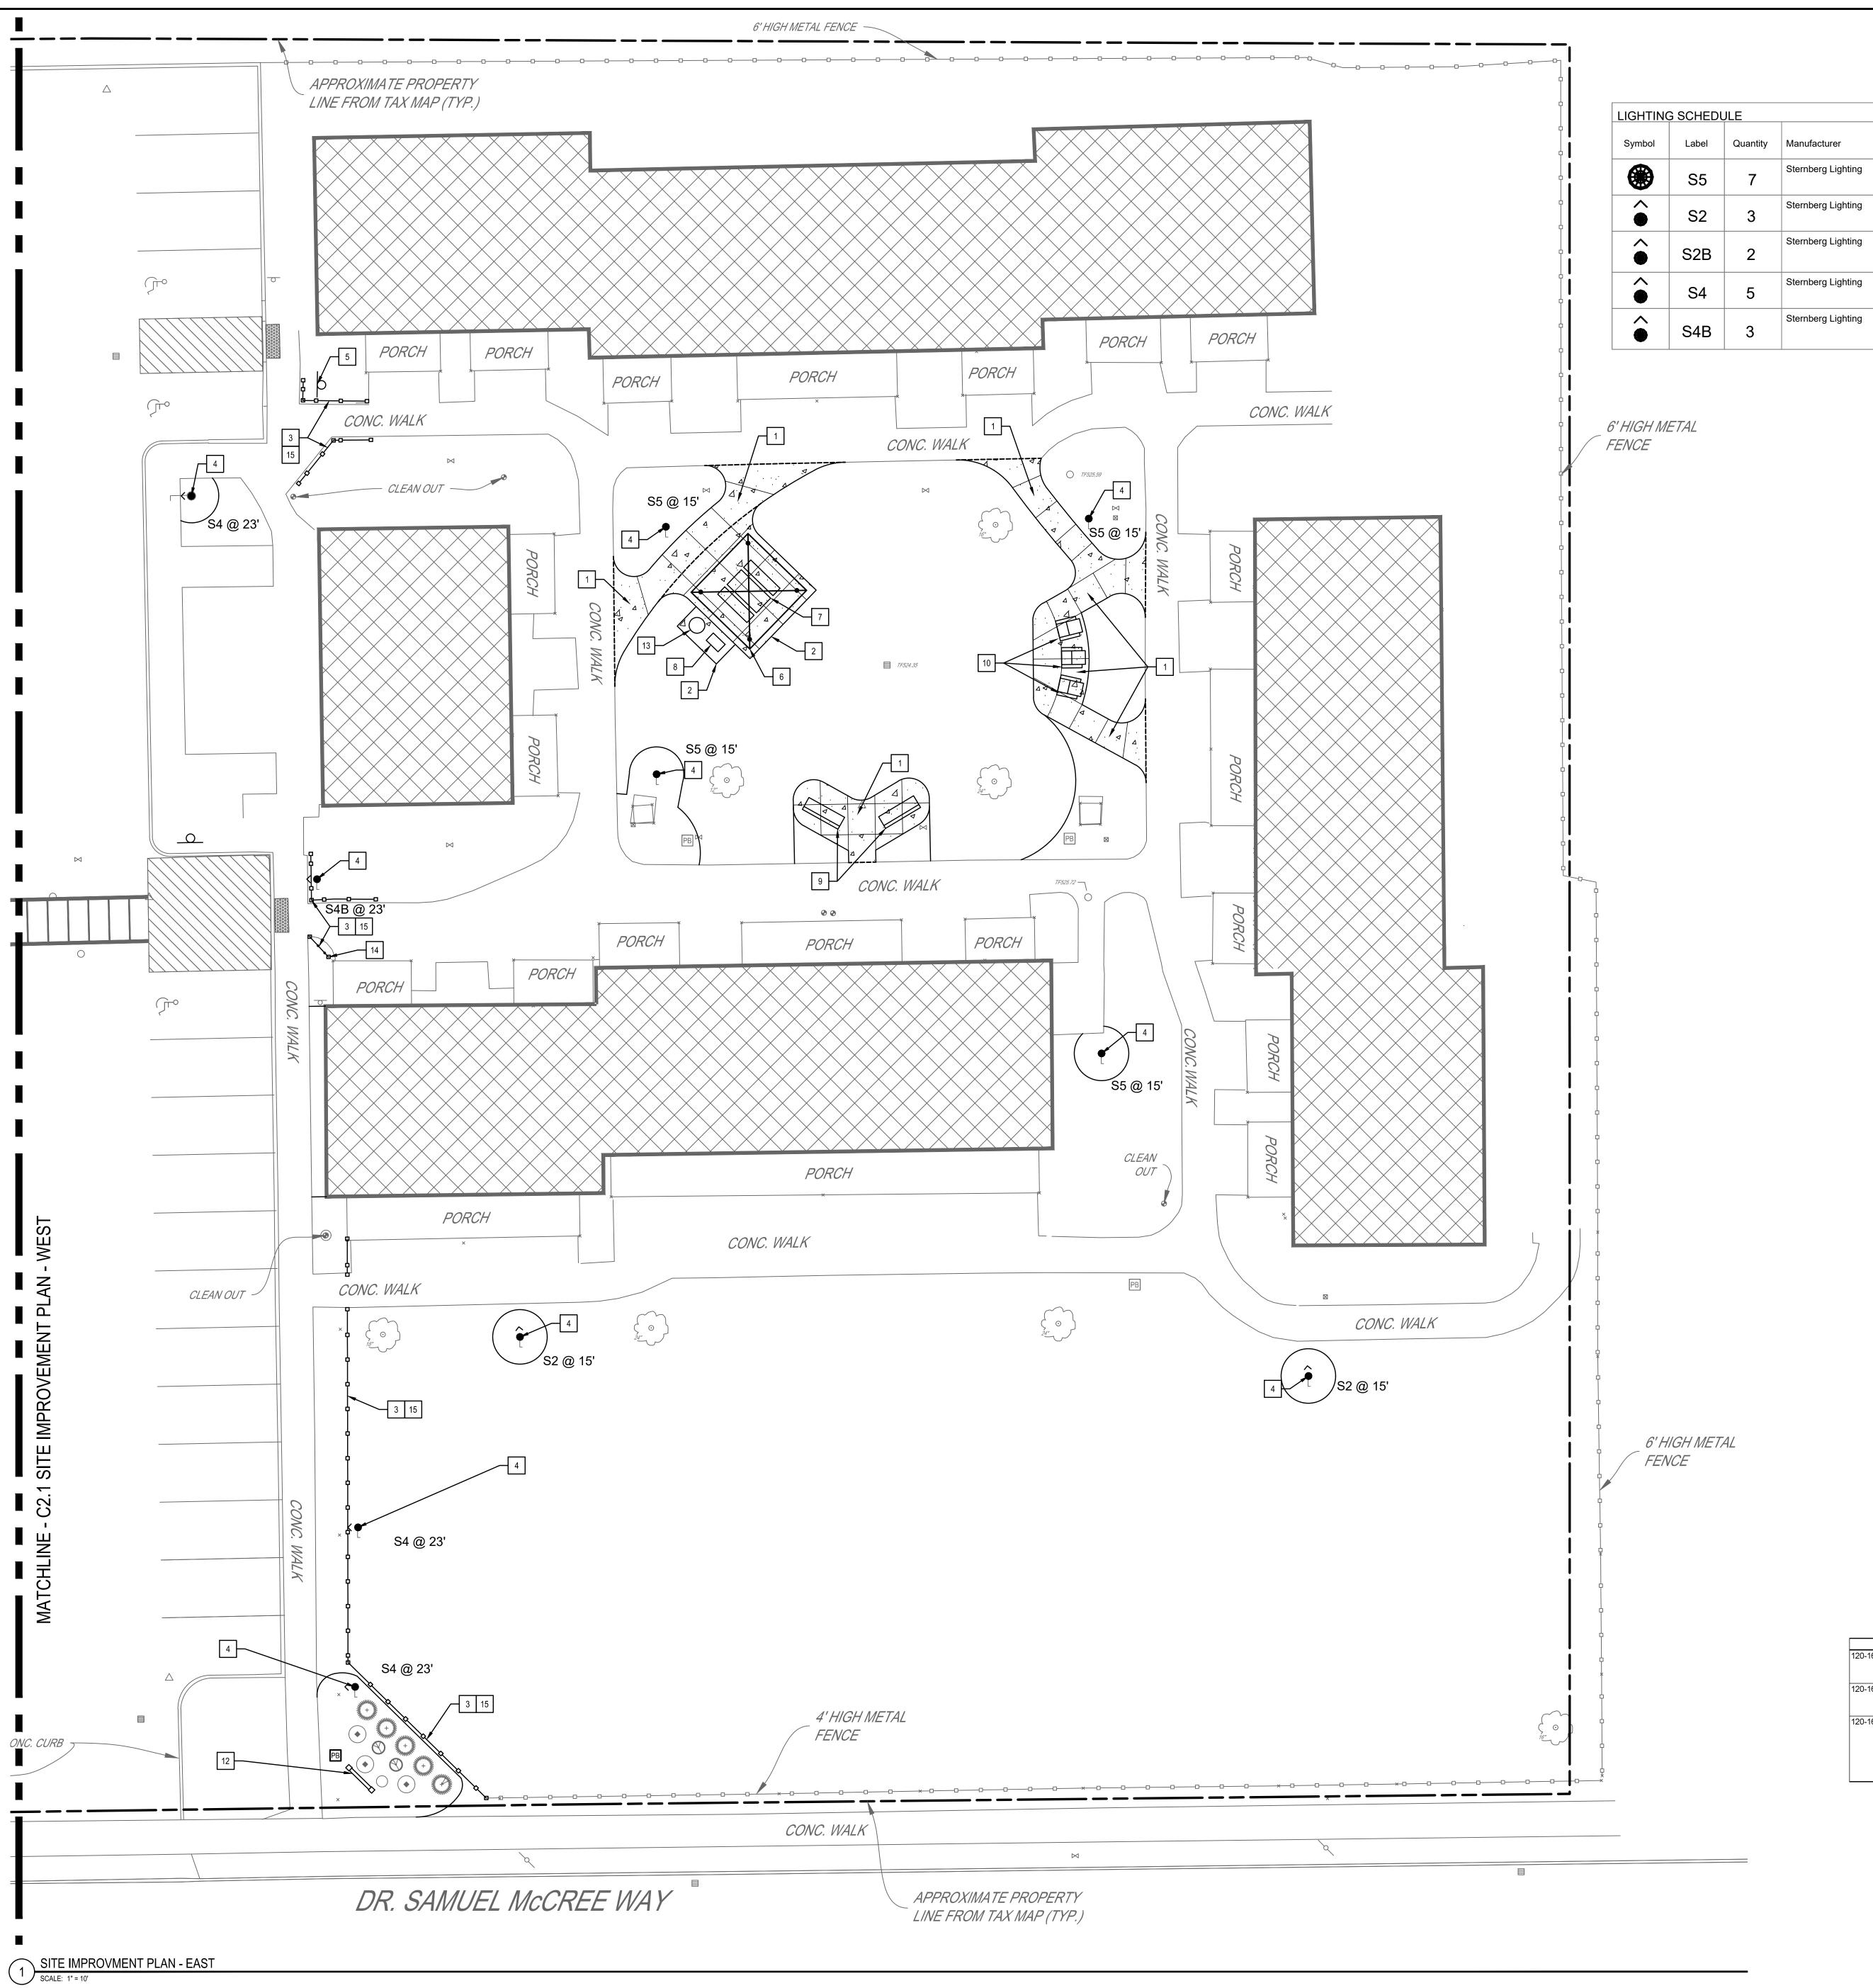

LIGHTING	LIGHTING SCHEDULE											
Symbol	Label	Quantity	Manufacturer	Catalog Number	Description	Filename	Number Lamps	Lumens Per Lamp	Light Loss Factor	Wattage		
	S5	7	Sternberg Lighting	SL660-12L40T5-MDL018- -CA	Medium size Post Top Mount fixture, T5, Clear Acrylic Flat	SL660-12L40T5- MDL018-CA.IES	1	5781	0.9	60.4		
•	S2	3	Sternberg Lighting	SL660-12L40T2-MDL014- -CA	Medium size Post Top Mount fixture, T2, Clear Acrylic Flat	SL660-12L40T2- MDL014-CA.IES	1	4837	0.9	46.3		
•	S2B	2	Sternberg Lighting	SL660-12L40T2-MDL014- -CA-BLOC	Medium size Post Top Mount fixture, T2, Clear Acrylic Flat-Rear Light Blocking	SL660-12L40T2- MDL014-CA- BLOC.IES	1	3558	1	45.6		
	S4	5	Sternberg Lighting	SL660-12L40T4-MDL014- -CA	Medium size Post Top Mount fixture, T4, Clear Acrylic Flat	SL660-12L40T4- MDL014-CA.IES	1	4660	1	46.1		
•	S4B	3	Sternberg Lighting	SL660-12L40T4-MDL014- -CA-BLOC	Medium size Solana Arm Mount fixture, T4, CA - Rear Light Blocking	SL660-12L40T4- MDL014-CA- BLOC.IES	1	3027	1	45.6		

CONCRETE SIDEWALK

SCORE JOINT
EXPANSION JOINT

BENCH

PICNIC TABLE

CHAIR

GARAGE CAN

12' x 12' PERGOLA

FENCE LINE

EXISTING LIGHT POLE BA

### GENERAL SITE NOTES:


1. SEE SITE LANDSCAPING PLANS FOR ALL PROPOSED PLANTINGS (NOT

- 2. LOCATIONS, SIZES, AND DEPTHS OF SUBSURFACE UTILITIES ARE BASED ON OUTDATED BLUEPRINTS FROM 1967. CONTRACTOR TO LOCATE ALL UNDERGROUND UTILITIES PRIOR TO THE START OF WORK. CONTRACTOR IS RESPONSIBLE FOR ANY DAMAGE TO EXISTING UTILITIES NOT OUTLINED IN THE SCOPE OF WORK.
- # SITE IMPROVEMENT NOTES:

  1. PROVIDE 5 INCH THICK CONCRETE SIDEWALK AND SUBBASE. SEE DETAIL 1 /
- PROVIDE CONCRETE PAD AND SUBBASE. SEE DETAIL 2 / C6.1.
   PROVIDE 4 FEET HIGH ORNAMENTAL ALUMINUM FENCE WITH CONCRETE FOOTINGS. SEE SPECIFICATIONS. MATCH EXISTING CONDITIONS FOR FENCE STYLE AND TYPE. REUSE SALVAGED FENCE SECTIONS FROM PHASE 2 CONSTRUCTION AND OWNER.
- PROVIDE LIGHT POLE AND FIXTURE ON EXISTING CONCRETE LIGHT POLE BASE AT MOUNTING HEIGHTS INDICATED. SEE LIGHTING SCHEDULE THIS SHEET AND DETAIL 8 / C6.1.
- PROVIDE SALVAGED ACCESSIBLE SPACE SIGNAGE AND POST. SEE DETAIL 7 /
- 6. PROVIDE 12 FEET BY 12 FEET SQUARE METAL SHADE STRUCTURE BY CREATIVE RECREATIONAL SYSTEMS, INC. (OR APPROVED EQUAL). SEE SPECIFICATIONS.
- 7. PROVIDE PICNIC TABLE AS SPECIFIED. SEE SPECIFICATIONS.
- 8. PROVIDE GRILL AS SPECIFIED. MOUNT TO PROPOSED CONCRETE PAD / WALK PER MANUFACTURER'S REQUIREMENTS. SEE SPECIFICIATIONS.
- 9. PROVIDE BENCH AS SPECIFIED. SEE SPECIFICATIONS.
- 10. PROVIDE EXTERIOR CHAIR AS SPECIFIED. SEE SPECIFICATIONS.
- PROPOSED DECORATIVE FENCE END POST SHALL BE IMMEDIATELY ADJACENT TO CHAIN LINK FENCE POST. MAXIMUM GAP BETWEEN POSTS SHALL BE 3 INCHES.
   PROVIDE MAIN ENTRANCE SIGN WITH BRICK PILLARS AND FOUNDATIONS. SEE
- DETAIL 9 / C6.1. SIGN FOUNDATIONS TO BE DESIGNED BY SIGN
  MANUFACTURER / PROVIDER. CITY ZONING SIGNAGE REQUIREMENTS SHALL
  BE MET WITH NEW SIGN. DETERMINATION WILL BE MADE IF ANY VARIANCES OR
  SPECIAL SITE PLAN APPROVALS ARE REQUIRED. SIGN MUST NOT BE
  MANUFACTURED OR INSTALLED UNTIL ARCHITECT HAS CONFIRMED A
  CERTIFICATE OF ZONING COMPLIANCE OR OTHER REQUIRED APPROVALS HAVE
  BEEN OBTAINED. CONTRACTOR TO CONFIRM WITH ARCHITECT PRIOR TO ANY
  SCOPE BEING INITIATED.
- 13. PROVIDE GARBAGE BIN AS SPECIFIED. SEE SPECIFICATIONS.
- 14. FOR FENCE POST NEAR PORCH CORNER, HAND DIG TO LOCATE EXISTING 18 INCH CONCRETE FOOTING AND PLACE FENCE POST CONCRETE BASE AS CLOSE AS POSSIBLE TO THE EXISTING BASE WITHOUT DISTURBING IT.
- 15. HAND DIG TO LOCATE EXISTING UTILITY LOCATIONS IN VICINITY OF PROPOSED FENCE. CORRECT FENCE LOCATION BASED ON EXISTING CONDITIONS AND PER OWNER'S FINAL APPROVAL.

CITY OF ROCHESTER REGULATIONS
SITE ZONING: R-1 / LOW DENSITY RESIDENTIAL

	ZONING CODE	REQUIRED:	PROVIDED:
120-165	DUMPSTERS AND REFUSE COLLECTION AREAS		
	REFUSE COLLECTION CONTAINERS SHALL BE SCREENED FROM VIEW OF RESIDENCES AND/OR		
	PUBLIC STREET	YES	YES
120-167	FENCES AND WALLS		
	WITHIN RESIDENTIAL DISTRICTS NO FENCING IN A FRONT YARD SHALL EXCEED 4'-0" IN HEIGHT	≤4'-0" HEIGHT	4'-0" HEIGHT
	WITHIN RESIDENTIAL DISTRICTS NO FENCING SHALL BE MORE THAN 60% SOLID	≤60%	YES
120-169	LANDSCAPING, BUFFERS, SCREENING		
	5'-0" LANDSCAPE AREA SHALL BE REQUIRED ALONG PUBLIC STREETS AND SIDEWALKS.		
	SHRUBS QTY WITHIN LANDSCAPED AREAS WILL BE A MIN. 1 SHRUB PER 15' OF PERIMETER.		
	507 LF PERIMETER/ 15 = 33.8 = 34 SHRUBS	34 SHRUBS	37 SHRUBS
	TREE QTY WITHIN LANDSCAPED AREAS WILL BE A MIN. 1 TREE PER 40' OF PERIMETER.		
	507 PERIMETER/ 40 = 12.68 = 13 TREES - 11 EXISTING TREES = 2 NEW TREES	2 NEW TREES	2 TREES

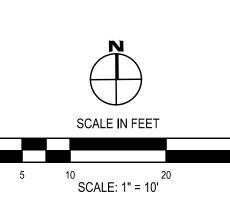

SITE IMPROVMENT PLAN - EAST
BRONSON COURT SITE UPGRADE
ROCHESTER HOUSING AUTHORITY

CHECKED BY:

09/05/2025 AS SHOWN

C2.2
PROJECT NO: 2285-054

CHECKED BY:

09/05/2025 AS SHOWN

0 10 20 SCALE: 1" = 20'

PROJECT NO: 2285-054

SITE LAYOUT PLAN
BRONSON COURT SITE UPGRADE P
ROCHESTER HOUSING AUTHORITY
90 SAMUEL McCREE WAY, ROCHESTER, NY 14608



GENERAL LAYOUT NOTE: A. ALL FILLETED EDGES ARE 3' RADIUS UNLESS OTHERWISE NOTED.

POINT TABLE				POINT TABLE					POINT TABLE				
POINT NO.	NORTHING	EASTING	DESCRIPTION	POINT NO.	NORTHING	EASTING	DESCRIPTION	F	POINT NO.	NORTHING	EASTING	DESCRIPTION	
100	1148008.60	1404347.34	PULL BOX	125	1148148.53	1404186.09	EDGE CONC		150	1147999.96	1404203.51	FENCE	
101	1148235.18	1404192.70	EDGE CONC	126	1148127.12	1404213.30	RADIUS PC		151	1148151.88	1404430.10	RADIUS PC	
102	1148137.83	1404269.54	LANDSCAPE EDGE	127	1148132.29	1404228.00	LANDSCAPE EDGE		152	1148141.72	1404426.77	EDGE CONC	
103	1148133.32	1404269.19	FENCE	128	1148087.71	1404245.06	EDGE CONC		153	1148145.30	1404416.21	RADIUS PC	
104	1148133.22	1404255.54	FENCE	129	1148087.51	1404231.06	EDGE CONC		154	1147999.69	1404183.72	FENCE	
105	1148060.56	1404262.80	FENCE	130	1148234.49	1404185.32	RADIUS PC		155	1147999.78	1404190.75	FENCE	
106	1148079.36	1404178.33	EDGE CONC	131	1148237.07	1404203.13	RADIUS PC		156	1148022.29	1404349.18	FENCE	
107	1148127.13	1404269.16	FENCE	132	1148235.40	1404206.19	EDGE CONC		157	1148202.04	1404352.29	FENCE	
108	1148127.19	1404255.59	FENCE	133	1148239.08	1404193.62	EDGE CONC		158	1148195.82	1404342.08	FENCE	
109	1148054.55	1404262.87	FENCE	134	1148148.35	1404192.31	RADIUS PC		159	1148198.75	1404422.27	RADIUS PC	
110	1148121.35	1404225.82	EDGE CONC	135	1148080.80	1404231.16	EDGE CONC		160	1148178.04	1404451.40	RADIUS PC	
111	1148123.98	1404223.62	RADIUS PC	136	1148061.75	1404228.37	EDGE CONC		161	1148163.13	1404457.11	RADIUS PC	
112	1148124.73	1404239.64	OH STRUCTURE	137	1148061.49	1404207.52	EDGE CONC		162	1148175.96	1404466.41	RADIUS PC	
113	1148112.66	1404244.57	EDGE CONC	138	1148066.61	1404225.98	RADIUS PC		163	1148151.65	1404466.52	RADIUS PC	
114	1148108.22	1404230.74	EDGE CONC	139	1148063.32	1404241.18	EDGE CONC		164	1148134.50	1404353.00	FENCE	
115	1148101.51	1404230.86	EDGE CONC	140	1148076.08	1404243.84	OH STRUCTURE		165	1148000.92	1404271.45	FENCE	
116	1148160.86	1404461.24	RADIUS PC	141	1148164.22	1404449.98	RADIUS PC		166	1148210.57	1404342.58	FENCE	
117	1148149.45	1404423.14	RADIUS PC	142	1148000.06	1404210.52	FENCE		167	1148145.58	1404433.21	RADIUS PC	
118	1148192.94	1404403.61	RADIUS PC	143	1148000.33	1404229.92	FENCE		168	1148006.83	1404348.83	MAIN SIGN	
119	1148207.74	1404351.70	FENCE	144	1148151.70	1404419.11	RADIUS PC		169	1148179.64	1404399.63	OH STRUCTURE	
120	1148194.92	1404451.95	RADIUS PC	145	1148169.89	1404408.28	EDGE CONC		170	1148244.46	1404193.51	EDGE CONC	
121	1148107.03	1404226.79	RADIUS PC	146	1148188.12	1404409.57	RADIUS PC		171	1148000.24	1404222.93	FENCE	
122	1148100.70	1404243.88	OH STRUCTURE	147	1148183.02	1404393.51	RADIUS PC		172	1148247.16	1404205.75	RADIUS PC	
123	1148153.42	1404192.32	RADIUS PC	148	1148139.97	1404426.80	EDGE CONC		173	1148140.94	1404343.71	FENCE	
124	1148153.89	1404211.62	EDGE CONC	149	1148165.80	1404388.41	RADIUS PC		174	1148060.70	1404270.56	FENCE	


		POINT TABLE									
7		POINT NO.	NORTHING	EASTING	DESCRIPTION						
		175	1148054.63	1404270.62	FENCE						
		176	1148074.00	1404349.08	FENCE						
		177	1147998.92	1404128.84	FENCE						
		178	1148017.08	1404344.82	RADIUS PC						
		179	1148153.59	1404205.35	RADIUS PC						
		180	1148148.52	1404205.43	RADIUS PC						
		181	1148002.37	1404369.51	CORNER FENCE						
		182	1147999.16	1404359.65	RADIUS PC						
		183	1148245.32	1404185.88	RADIUS PC						
	1				-						


DRAWN BY:

CHECKED BY:

09/05/2025

AS SHOWN

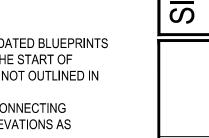

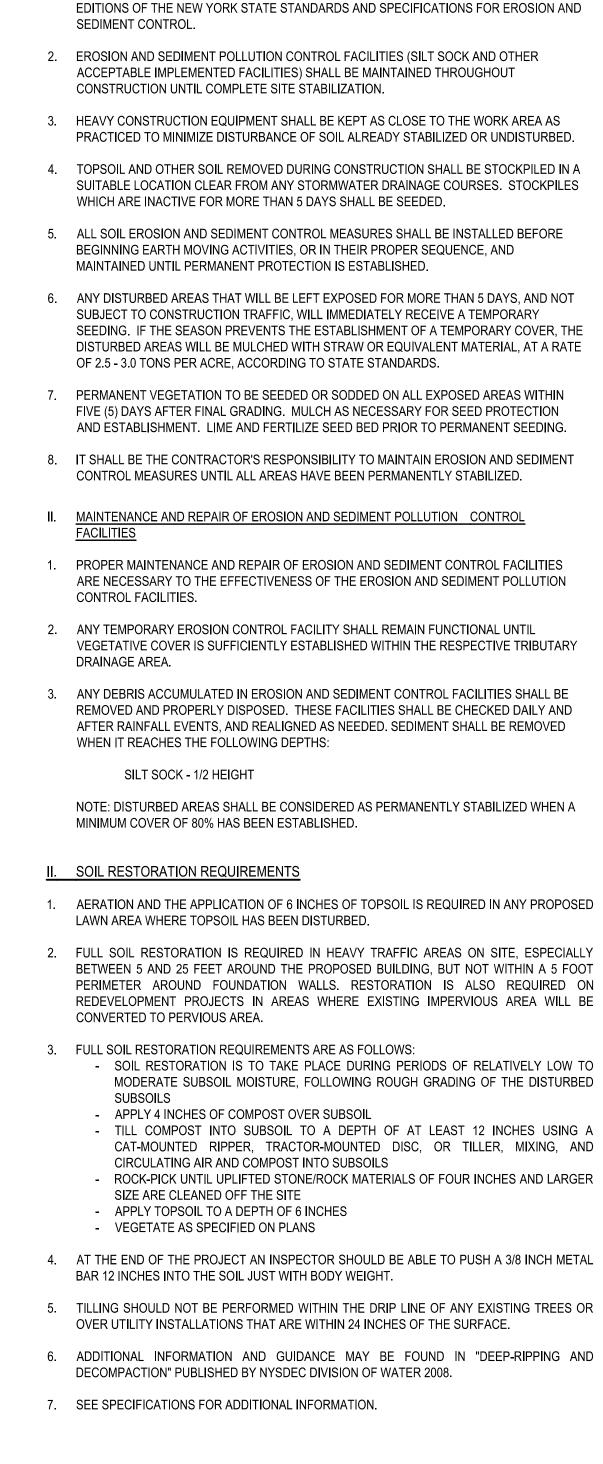

EROSION & SEDIMENT POLLUTION CONTROL (E & SPC) GUIDELINES

1. EROSION AND SEDIMENT POLLUTION CONTROL FACILITIES AND PRACTICES, UTILIZED IN

THE CONSTRUCTION OF THE PROJECT, SHALL BE CONSISTENT WITH THE LATEST

# GENERAL NOTE: SEE SITE IMPROVEMENT PLAN FOR LIGHTING SCOPE IN PROJECT.

## $\langle \# \rangle$ SITE UTILITY NOTES:

LINE FROM TAX MAP (TYP.)

LINE FROM TAX MAP (TYP.

× 525.88 —

1. CONTRACTOR TO MAINTAIN EXISTING DRAINAGE PATHWAYS ON SITE. THIS INCLUDES, BUT IS NOT

2. SIDEWALKS TO MATCH THE EXISTING CHARACTER OF THE LAND AND TIE INTO EXISTING GRADE.

1. PROVIDE CONCRETE WASHOUT STATION. LOCATION TO BE DETERMINED BY OWNER AND

2. PROVIDE INLET PROTECTION AS INDICATED ON THE PLAN. SEE DETAIL 2 ON THIS SHEET.

3. PROVIDE SOIL STOCK PILE LOCATION. SEE DETAIL 4 ON THIS SHEET. LOCATIONS TO BE

4. PROVIDE STAGING AREA LOCATION. LOCATIONS TO BE DETERMINED BY OWNER AND

CONTRACTOR ON SITE. APPROVED BY ARCHITECT AND RHA REPRESENTATIVE.

INLET PROTECTION

**CONCRETE WASHOUT** 

TOPSOIL STOCKPILE

STAGING AREA

DETERMINED BY OWNER AND CONTRACTOR ON SITE. APPROVED BY ARCHITECT AND RHA

ALL SIDEWALKS AND CONCRETE PADS AWAY FROM THE BUILDINGS.

3. GROUND DISTURBANCE FOR PHASE 3 (THIS PHASE) IS 7,500 SF.

SITE EROSION AND SEDIMENT CONTROL PLAN NOTES:

CONTRACTOR ON SITE. SEE DETAIL 3 ON THIS SHEET.

LIMITED TO; GRADE / SLOPE OF THE GROUND TOWARD CATCH BASINS OR GUTTERS, AND SLOPE OF

SITE GRADING AND UTILITY PLAN

CROSS-SLOPE NOT TO EXCEED 2%.

REPRESENTATIVE.

**LEGEND** 

GENERAL GRADING NOTES:

× 526.15

1. GENERAL CONTRACTOR TO PROVIDE TRENCHING AND BACKFILL FOR NEW ELECTRICAL SCOPE. SEE DETAIL 11 / C6.1.

- O/H - 523.44 O/H 523.33 O/H O/H + O/H - 523.73 O/H - O/H - O/H - 523.73 O/H - O

- 2. THE ELECTRICAL CONTRACTOR TO PROVIDE 2#12,1#12G IN 1" UNDERGROUND SCHEDULE 80 PVC CONDUIT FROM SLEEVE ON EXISTING LIGHT POLE AND STUB UP TO CONNECT INTO EXTERIOR PULL BOX INSTALLED IN LOCATION SHOWN (AT SIGN AREA ONLY). CONTRACTOR TO COORDINATE FINAL INSTALLED LOCATIONS WITH OTHERS PRIOR TO STARTING WORK. REFER TO DETAIL 11 / C6.1.
- 3. GENERAL CONTRACTOR TO INSTALL PULL BOX (FROM PHASE II, OBTAIN FROM OWNER) FOR
- ELECTRICAL CONDUIT AT SIGN AREA ONLY.
- 4. RAISE CATCH BASIN GRATE ELEVATION TO NEW SPOT ELEVATION SHOWN ON THE PLAN. SEE SPECIFICATIONS.
- 5. ALL BUILDING STORM LEADERS THAT GO UNDERGROUND AT THE DOWNSPOUTS NEED TO BE CLEANED OUT OF DEBRIS, LEAVES, AND GARBAGE AT THE DOWNSPOUT CONNECTOR AND WITHIN THE UNDERGROUND PIPE (TYP.). ALL LOCATIONS MAY NOT BE SHOWN. ENSURE ALL STORM PIPES ARE FREE FLOWING AND ARE NOT CLOGGED.

# TIE OPEN ENDS AND OVERLAP WITH WIRE 2"x2" WOOD -STAKES STANDARD INLET CURB INLET - OPTION B **CURB INLET - OPTION A**

APPROXIMATE PROPERTY

LINE FROM TAX MAP (TYP.)

### INSTALLATION NOTES

APPROXIMATE PROPERT. LINE FROM TAX MAP (TYP.)

\* 528.632 352 <del>352</del>8.8325.84

525.325.246 ST × 1925.60 ST \* 525.62 W ---

× 524 73

- 1. COMPOST SOCKS SHALL BE INSTALLED PRIOR TO ANY LAND-DISTURBING
- COMPOST SOCKS SHALL BE "SILT SOCK", "FILTEREXX" OR OTHER APPROVED
- 3. COMPOST SOCKS SHALL BE FILLED WITH WOOD CHIPS OR COMPOST. SEE SPECIFICATIONS FOR APPROVED COMPOSITION OF WOOD CHIPS OR
- 4. COMPOST SOCKS SHALL BE INSTALLED PER MANUFACTURERS SPECIFICATIONS.
- SURFACE. WOOD STAKES SHALL BE USED TO SECURE THE WATTLES, 1/2" TO 5/8"
- ENOUGH TO PROTRUDE SEVERAL INCHES ABOVE THE WATTLE. EXCESS FABRIC SHALL BE WRAPPED AROUND THE STAKES FOR INLETS NOT ON A CURB THE COMPOST SOCK SHALL BE TIED OFF AT

SEDIMENT ACCUMULATED BEHIND WATTLE SHALL BE REMOVED OF THE SILT/COMPOST SOCK.

COMPOST/SILT SOCK INLET PROTECTION DETAIL

- ACTIVITIES.
- FILTER FABRIC SOCK
- COMPOST
- COMPOST SOCK SHALL BE IN CONSTANT CONTACT WITH THE GROUND
- REBAR IS ALSO ACCEPTABLE. BE SURE TO USE A STAKE THAT IS LONG
- BOTH ENDS WITH TIE WIRE AND OVERLAPPED TO PROVIDE SUITABLE PROTECTION.

# ☐ **/**— 2"x2" WOODEN STAKE TIE COMPOST SOCK BASIN SECURELY TO GRATE WITH RUBBER TIES

WHEN SEDIMENT HAS ACCUMULATED TO ONE-HALF THE DIAMETER

CONCRETE WASH OUT DETAIL

# STABILIZE ENTIRE PILE WITH SEED OR PLASTIC COVER.


### SOIL STOCKPILING NOTES:

SLOPE

AREA CHOSEN FOR STOCKPILING OPERATIONS SHALL BE DRY AND STABLE. MAXIMUM SLOPE OF STOCKPILE SHALL BE 1:2. UPON COMPLETION OF SOIL STOCKPILING, EACH PILE SHALL BE SURROUNDED WITH SILT FENCING AND THEN STABILIZED WITH SEED OR SECURED

SILT FENCE

IMPERVIOUS COVER. 4. SEE SILT FENCE INSTALLATION DETAIL

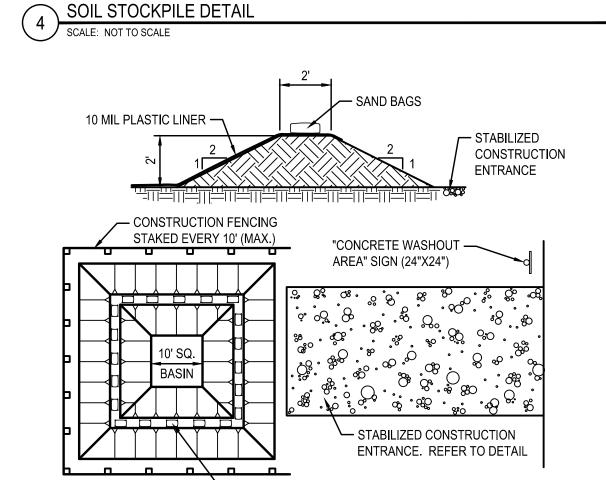

1. ALL TOOLS AND EQUIPMENT UTILIZED DURING ANY CONCRETE CONSTRUCTION, INCLUDING HAND TOOLS, WHEELBARROWS, TRUCKS, CHUTES SHALL UTILIZE THE CONCRETE WASHOUT AREA.

2. WASHOUT AREA TO BE MAINTAINED AND CLEANED OUT PERIODICALLY TO PREVENT

WASHWATER AND/OR SOLIDS FROM EXITING THE WASHOUT TRAP.

THE SCOPE OF WORK.

CONTRACTOR TO FIELD VERIFY ALL ELEVATIONS AT PARKING LOT SIDEWALKS. CONNECTING SIDEWALKS SHALL BE ADJUSTED TO MEET EXISTING PARKING LOT SIDEWALK ELEVATIONS AS

1. APPLY LIMESTONE (EQUIVALENT TO 50 PERCENT (50%) CALCIUM PLUS MAGNESIUM OXIDES) AT A RATE OF 90 POUNDS PER 1,000 SQUARE FEET. APPLY FERTILIZER AT A RATE OF 600 POUNDS

2. WORK LIME AND FERTILIZER INTO SOIL AS NEARLY AS PRACTICAL TO A DEPTH OF 4 INCHES WITH A DISC. SPRINGTOOTH HARROW OR OTHER SUITABLE EQUIPMENT. THE FINAL HARROWING OR DISCING OPERATION SHOULD BE ON THE GENERAL CONTOUR. CONTINUE TILLAGE UNTIL A REASONABLY UNIFORM SEEDBED IS PREPARED.

3. INSPECT SEEDBED JUST BEFORE SEEDING. IF TRAFFIC HAS LEFT THE SOIL COMPACT, THE AREA MUST BE RETILLED AS ABOVE

PER ACRE OR 14 POUNDS PER 1,000 SQUARE FEET USING 10-20-10 OR EQUIVALENT.

### TEMPORARY REQUIREMENTS

SEEDBED PREPARATION:

# SEEDING:

a. APPLY LAWN MIX AT A RATE (SEE SPECIFICATIONS)

III. MULCHING AND SEEDING REQUIREMENTS


- b. APPLY SEED WITH MECHANICAL SEEDER. OPTIMUM SEEDING DEPTH IS ONE INCH (EXCEPT SANDY SOILS, 2 INCHES).
- c. WHERE FEASIBLE, EXCEPT WHERE EITHER A CULTIPACKER TYPE SEEDER OR HYDROSEEDER IS USED, THE SEEDBED SHALL BE FIRMED FOLLOWING SEEDING OPERATIONS WITH A ROLLER, OR LIGHT DRAG. SEEDING OPERATIONS SHOULD BE ON THE

### CONTOUR. MULCHING

- a. MULCH MATERIALS SHALL BE SMALL GRAIN STRAW AT A RATE OF 2-1/2 TO 3 TONS PER ACRE, OR 70 TO 90 POUNDS PER 1,000 SQUARE FEET. MULCH SHOULD NOT BE GROUND OR CHOPPED INTO SHORT PIECES.
- b. SPREAD UNIFORMLY BY HAND OR MECHANICALLY SO THAT APPROXIMATELY 75 PERCENT TO 95 PERCENT OF THE SOIL SURFACE WILL BE COVERED.
- c. MULCH ANCHORING SHALL BE ACCOMPLISHED IMMEDIATELY AFTER PLACEMENT TO MINIMIZE LOSS BY WIND OR WATER. 1. MULCHING NETTINGS - STAPLE, JUTE OR COTTON NETTINGS TO THE SOIL SURFACE. USE A DEGRADABLE NETTING IN AREAS TO BE MOWED.

### PERMANENT SEEDING

PERMANENT SEEDING TO BE INSTALLED PER MANUFACTURER'S SPECIFICATIONS.

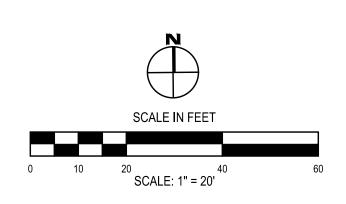

### **GENERAL SITE NOTES:**

1. LOCATIONS, SIZES, AND DEPTHS OF SUBSURFACE UTILITIES ARE BASED ON OUTDATED BLUEPRINTS FROM 1967. CONTRACTOR TO LOCATE ALL UNDERGROUND UTILITIES PRIOR TO THE START OF WORK. CONTRACTOR IS RESPONSIBLE FOR ANY DAMAGE TO EXISTING UTILITIES NOT OUTLINED IN

PROJECT NO: 2285-054

DRAWN BY:

CHECKED BY:

09/05/2025

AS SHOWN



PROJECT NO: 2285-054

LEGEND: -SEE NOTES AND SPECIFICATIONS PLANTING BED, TYP. -SEE NOTES AND SPECIFICATIONS PLANTING BED EDGING, TYP. PLANTINGS - SEE PLANT SCHEDULE, TYP.

### GENERAL PLANTING NOTES:

6' HIGH METAL FENCE —

CONC. WALK

Q 524.00

6' HIGH METAL

4' HIGH METAL

FENCE

1 LANDSCAPE PLAN - WEST SCALE: 1" = 10'

ركب

CONC. WALK

Q 523.44

**⋈** 522.67

CONC. WALK

- A. CONTRACTOR TO EVALUATE EXISTING SITE CONDITIONS AND REMEDY AS REQUIRED TO PROVIDE FOR HEALTHY PLANT GROWTH AND MITIGATE UNSIGHTLY CONDITIONS.
- B. SEE ALL DEMO SHEETS FOR LANDSCAPE TO BE REMOVED AND TO REMAIN.
- C. SEE SPECIFICATIONS FOR ALL LANDSCAPING MAINTENANCE AND TOPSOIL REQUIREMENTS.
- D. AMEND TOPSOIL IN PLANTING BEDS AS SPECIFIED.
- E. COORDINATE STOCKPILING AND PLACEMENT OF REQUIRED IMPORTED TOPSOIL TO ACHIEVE FINISH GRADE. AFTER INCORPORATION OF SUPPLEMENTAL SOIL AMENDMENT PRODUCTS, FINISH GRADE ALL PLANTING AREAS SMOOTH (FREE OF PEAKS OR DEPRESSIONS) PRIOR TO PLACEMENT OF PLANTING MATERIAL AND
- F. PLACE TOPSOIL AND RE-GRADE ALL DISTURBED BY CONTRACTOR'S OPERATIONS AS PER PLANS AND SPECIFIED. DISTURBED AREAS SHALL BE WHERE CONSTRUCTION ACTIVITIES INCLUDING TRENCHING, DEMOLITION, EARTHWORK, MATERIAL STORAGE, STAGING, PARKING OR ANY OTHER FORM OF EXCAVATION, COMPACTION, OR TRAFFIC RESULTS IN THE REMOVAL OR DISPLACEMENT OF EXISTING GROUND COVER OR GRADE. PROVIDE SMOOTH CLEAN TRANSITION FROM EXISTING TO DISTURBED AREA.
- G. PROVIDE LANDSCAPE FABRIC UNDER ALL MULCH. H. PROVIDE RESTORATION AND SEED FOR ALL DISTURBED AREAS AS SPECIFIED.
- I. SEE SPECIFICATIONS FOR MORE INFORMATION ON PLANTING AND PLANTS. J. PROVIDE SOIL TEST AND AMEND EXISTING TOPSOIL TO MEET SOIL VIABILITY
- REQUIREMENTS- SEE PLANTS SPECIFICATION.
- K. PROVIDE ORGANIC MULCH OVER FABRIC AS SPECIFIED AT ALL PLANTING AREAS,


### PLANTING PLAN NOTES:

- 1. PROVIDE (NEW) DECIDUOUS TREE PLANTING. SEE DETAIL 5 / C6.1.
- 2. PROVIDE SHRUB PLANTING. SEE DETAIL 3 / C6.1.
- 3. PROVIDE PERENNIAL PLANTING. SEE DETAIL 4 / C6.1.
- 4. PROVIDE LANDSCAPE EDGING AS SPECIFIED. ANY BEDS WITHOUT PHYSICAL EDGING SHALL BE INSTALLED PER DETAIL 10 / C6.1. AT TRANSITION BETWEEN LAWN AND LADSCAPE BED, PROVIDE SHOVELED BED EDGE PER DETAIL 9 / C6.1. BEDS AROUND LIGHT POLES ARE 8 FEET IN DIAMETER (AROUND 2 FEET DIAMETER BASES; THEREFORE, ACTUAL BED WIDTH IS 3 FEET).
- 5. PROVIDE (SALVAGED) DECIDUOUS TREE PLANTING. SEE DETAIL 5 / C6.1. SECOND SALVAGED TREE LOCATION NOT SHOWN AND SHOULD BE CONFIRMED WITH OWNER PRIOR TO REPLANTING.
- 6. PROVIDE 1 FEET WIDE MULCHED MOW STRIP UNDER EXISTING AND PROPOSED FENCE. PORTIONS OF MOW STRIP ARE SHOWN ON ADJACENT PROPERTIES. OWNER SHALL OBTAIN APPROPRIATE APPROVAL FROM ALL APPLICABLE PROPERTY OWNER'S FOR SCOPE ON OTHER PROPERTIES PRIOR TO CONSTRUCTION. CONTRACTOR TO CONFIRM WITH OWNER THAT APPROVAL HAS BEEN OBTAINED PRIOR TO CONSTRUCTION. SEE DETAIL 9 / C6.1. SECTIONS OF FENCE ALONG SIDEWALK SHALL BE WIDE ENOUGH TO ENSURE MULCH IS EDGED ALONG WALK AND NO GRASS STRIPS ARE PROVIDED IN BETWEEN MULCH AND WALK.
- 7. TRIM ALL EXISTING MATURE TREES THAT EXTEND INTO THE PROPERTY FROM ADJACENT PROPERTIES INCLUDING, BUT NOT LIMITED TO, BRANCHES THAT INTERFERE WITH BUILDING ROOFS OR WALLS, DEAD BRANCHES, OR AS DIRECTED BY OWNER (TYP.). SEE SPECIFICATIONS. OWNER SHALL PROVIDE APPROPRIATE NOTIFICATION TO ADJACENT OWNERS THAT TRIMMING OF THEIR TREES ON RHA PROPERTY WILL BE COMPLETED. CONTRACTOR TO CONFIRM OWNER HAS DONE SO PRIOR TO CONSTRUCTION.

	ester	NY USDA Zones: 6a: -10°F to -5°F						
TRE		111 03DA 2011es. 0a10 1 to -3 1						
QTY	SYM	BOTANICAL NAME	COMMON NAME	SIZE	COND.	HEIGHT	WIDTH	COMMENTS
1		Lagerstroemia 'Tonto'	CRAPE MYRTLE 'TONTO'	5 GAL	CTN.	10'	8'	SPECIMEN -ORNAMENTAL TREE FORM
6			CONSTELLATION DOGWOOD	2.5" GAL	B&B	15'-20'	12'-18'	SPECIMEN -ORNAMENTAL TREE FORM
SHR	UBS		-	•	-		•	
QTY	SYM	BOTANICAL NAME	COMMON NAME	SIZE	COND.	HEIGHT	WIDTH	COMMENTS
24	FS	Forsythia 'Showoff Sugar Baby'	SHOW OFF SUGAR BABY FORSYTHIA	5 GAL	CTN.	30"		FULL
3	HQ	Hydrangea quercifolia 'Munchkin'	MUNCHKIN HYDRANGEA	5 GAL	CTN.	3-4'	3'-4.5'	FULL
22	НС	Heuchera villosa 'Caramel'	CORAL BELLS	1 GAL	CTN.	16-18"	16-18"	SPACING 16" O.C.
10	PG	Picea pungens 'Glauca Globosa'	GLAUCA GLOBOSA COLORADO SPRUCE	5 GAL	CTN.	3'-5'	4'-6'	FULL
3	PF	Potentilla fruitcosa 'Goldfinger'	YELLOW POTENTILLA	5 GAL	CTN.	2-3'	3-4'	FULL
1	ТМ	Taxus x media 'Densiformis'	DENSE SPREADING YEW	1 GAL	CTN.	3'-4'	7'	TRIMMED
PER	ENNIA	ALS		•				
QTY	SYM	BOTANICAL NAME	COMMON NAME	SIZE	COND.	HEIGHT	WIDTH	COMMENTS
11	NR	Nepeta racemosa 'Walker's Low	WALKER'S LOW CATMINT	1 GAL	CTN.	2'-2.5'	2.5'-3'	SPACING 36" O.C.
6	FG	Festuca glauca 'Boulder Blue'	BOULER BLUE FESCUE	1 GAL	CTN.	12"	12"	SPACING 10' O.C.
3	CA	Carex applachina	APPALACHIAN SEDGE	1 GAL	CTN.	6-8"	12-18"	SPACING 16" O.C.
16	НН	Hosta 'Halcyon'	PLANTAIN LILY	1 GAL	CTN.	18-24"	30-36"	SPACING 24" O.C.
6		Aurinia saxatilis	BASKET OF GOLD	1 GAL	CTN.	6-12"	12-18"	SPACING 18" O.C.
48	HS	Helictotrichon sempervirens	BLUE OAT GRASS	1 GAL	CTN.	2-3"	2-3"	SPACING 24" O.C.
3		Schizachyrium scoparium 'The Blues'	THE BLUE LITTLE BLUESTEM	1 GAL	CTN.	2-4'	1.5-2'	SPACING 24" O.C.
10		Liriope muscari	MONKEY GRASS	1 GAL	CTN.	12-18"	12-18"	SPACING 18" O.C.
3		Melica altissima 'Red Spire'	RED SPIRE GRASS	1GAL	CTN.	3-4'	2-3'	SPACING 24" O.C.
24	HA	Hakonechloa macra 'Aureola'	JAPANSES FOREST GRASS	1 GAL	CTN.	1-2'	2-4'	SPACING 18" O.C.
GRO	UND	COVER AND FERN						
QTY	SYM	BOTANICAL NAME	COMMON NAME	SIZE	COND.	HEIGHT	WIDTH	COMMENTS
		Juniperus horizontalis 'Wiktonii"	BLUE RUG CREEPING JUNIPER	5 GAL	CTN.	4-6"	4-6'	SPACING 5' O.C.
3	JH	Jumperus nonzontans viktorii	BEGE ROG GREET ING SOMI ER	0 0/12	O 114.	, 0	7 0	01 701110 0 0.0.
3 17		Athyrium niponicum	JAPANSES PAINTED FERN	1 GAL	CTN.	12-18"		SPACING 12" O.C.

### GENERAL SITE NOTES:

1. LOCATIONS, SIZES, AND DEPTHS OF SUBSURFACE UTILITIES ARE BASED ON OUTDATED BLUEPRINTS FROM 1967. CONTRACTOR TO LOCATE ALL UNDERGROUND UTILITIES PRIOR TO THE START OF WORK. CONTRACTOR IS RESPONSIBLE FOR ANY DAMAGE TO EXISTING UTILITIES NOT OUTLINED IN THE SCOPE OF WORK.

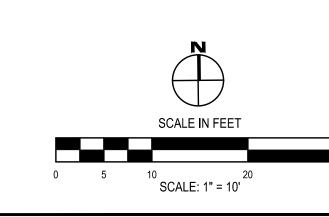

### GENERAL PLANTING NOTES:

- A. CONTRACTOR TO EVALUATE EXISTING SITE CONDITIONS AND REMEDY AS REQUIRED TO PROVIDE FOR HEALTHY PLANT GROWTH AND MITIGATE UNSIGHTLY CONDITIONS.
- B. SEE ALL DEMO SHEETS FOR LANDSCAPE TO BE REMOVED AND TO REMAIN.
- C. SEE SPECIFICATIONS FOR ALL LANDSCAPING MAINTENANCE AND TOPSOIL REQUIREMENTS.
- D. AMEND TOPSOIL IN PLANTING BEDS AS SPECIFIED.
   E. COORDINATE STOCKPILING AND PLACEMENT OF REQUIRED IMPORTED TOPSOIL TO ACHIEVE FINISH GRADE. AFTER INCORPORATION OF SUPPLEMENTAL SOIL AMENDMENT PRODUCTS, FINISH GRADE ALL PLANTING AREAS SMOOTH (FREE OF PEAKS OR DEPRESSIONS) PRIOR TO PLACEMENT OF PLANTING MATERIAL AND
- F. PLACE TOPSOIL AND RE-GRADE ALL DISTURBED BY CONTRACTOR'S OPERATIONS AS PER PLANS AND SPECIFIED. DISTURBED AREAS SHALL BE WHERE CONSTRUCTION ACTIVITIES INCLUDING TRENCHING, DEMOLITION, EARTHWORK, MATERIAL STORAGE, STAGING, PARKING OR ANY OTHER FORM OF EXCAVATION, COMPACTION, OR TRAFFIC RESULTS IN THE REMOVAL OR DISPLACEMENT OF EXISTING GROUND COVER OR GRADE. PROVIDE SMOOTH CLEAN TRANSITION FROM EXISTING TO DISTURBED AREA.
- G. PROVIDE LANDSCAPE FABRIC UNDER ALL MULCH.
  H. PROVIDE RESTORATION AND SEED FOR ALL DISTURBED AREAS AS SPECIFIED.
  I. SEE SPECIFICATIONS FOR MORE INFORMATION ON PLANTING AND PLANTS.
- J. PROVIDE SOIL TEST AND AMEND EXISTING TOPSOIL TO MEET SOIL VIABILITY REQUIREMENTS- SEE PLANTS SPECIFICATION.
- K. PROVIDE ORGANIC MULCH OVER FABRIC AS SPECIFIED AT ALL PLANTING AREAS, TYP.


### PLANTING PLAN NOTES:

- 1. PROVIDE (NEW) DECIDUOUS TREE PLANTING. SEE DETAIL 5 / C6.1.
- 2. PROVIDE SHRUB PLANTING. SEE DETAIL 3 / C6.1.
- 3. PROVIDE PERENNIAL PLANTING. SEE DETAIL 4 / C6.1.
- 4. PROVIDE LANDSCAPE EDGING AS SPECIFIED. ANY BEDS WITHOUT PHYSICAL EDGING SHALL BE INSTALLED PER DETAIL 10 / C6.1. AT TRANSITION BETWEEN LAWN AND LADSCAPE BED, PROVIDE SHOVELED BED EDGE PER DETAIL 9 / C6.1. BEDS AROUND LIGHT POLES ARE 8 FEET IN DIAMETER (AROUND 2 FEET DIAMETER BASES; THEREFORE, ACTUAL BED WIDTH IS 3 FEET).
- 5. PROVIDE (SALVAGED) DECIDUOUS TREE PLANTING. SEE DETAIL 5 / C6.1. SECOND SALVAGED TREE LOCATION NOT SHOWN AND SHOULD BE CONFIRMED WITH OWNER PRIOR TO REPLANTING.
- 6. PROVIDE 1 FEET WIDE MULCHED MOW STRIP UNDER EXISTING AND PROPOSED FENCE. PORTIONS OF MOW STRIP ARE SHOWN ON ADJACENT PROPERTIES. OWNER SHALL OBTAIN APPROPRIATE APPROVAL FROM ALL APPLICABLE PROPERTY OWNER'S FOR SCOPE ON OTHER PROPERTIES PRIOR TO CONSTRUCTION. CONTRACTOR TO CONFIRM WITH OWNER THAT APPROVAL HAS BEEN OBTAINED PRIOR TO CONSTRUCTION. SEE DETAIL 9 / C6.1. SECTIONS OF FENCE ALONG SIDEWALK SHALL BE WIDE ENOUGH TO ENSURE MULCH IS EDGED ALONG WALK AND NO GRASS STRIPS ARE PROVIDED IN BETWEEN MULCH AND WALK.
- 7. TRIM ALL EXISTING MATURE TREES THAT EXTEND INTO THE PROPERTY FROM ADJACENT PROPERTIES INCLUDING, BUT NOT LIMITED TO, BRANCHES THAT INTERFERE WITH BUILDING ROOFS OR WALLS, DEAD BRANCHES, OR AS DIRECTED BY OWNER (TYP.). SEE SPECIFICATIONS. OWNER SHALL PROVIDE APPROPRIATE NOTIFICATION TO ADJACENT OWNERS THAT TRIMMING OF THEIR TREES ON RHA PROPERTY WILL BE COMPLETED. CONTRACTOR TO CONFIRM OWNER HAS DONE SO PRIOR TO CONSTRUCTION.

		SCHEDULE						
		NY USDA Zones: 6a: -10°F to -5°F						
TRE								
QTY	SYN		COMMON NAME	SIZE	COND.	HEIGHT	WIDTH	COMMENTS
1	LT	Lagerstroemia 'Tonto'	CRAPE MYRTLE 'TONTO'	5 GAL	CTN.	10'	8'	SPECIMEN -ORNAMENTAL TREE FORM
6	CK	Cornus 'Rutcan'	CONSTELLATION DOGWOOD	2.5" GAL	B&B	15'-20'	12'-18'	SPECIMEN -ORNAMENTAL TREE FORI
SHR	UBS							
QTY	SYN	BOTANICAL NAME	COMMON NAME	SIZE	COND.	HEIGHT	WIDTH	COMMENTS
24	FS	Forsythia 'Showoff Sugar Baby'	SHOW OFF SUGAR BABY FORSYTHIA	5 GAL	CTN.	30"	36"	FULL
3	HQ	Hydrangea quercifolia 'Munchkin'	MUNCHKIN HYDRANGEA	5 GAL	CTN.	3-4'	3'-4.5'	FULL
22	НС	Heuchera villosa 'Caramel'	CORAL BELLS	1 GAL	CTN.	16-18"	16-18"	SPACING 16" O.C.
10	PG	Picea pungens 'Glauca Globosa'	GLAUCA GLOBOSA COLORADO SPRUCE	5 GAL	CTN.	3'-5'	4'-6'	FULL
3	PF	Potentilla fruitcosa 'Goldfinger'	YELLOW POTENTILLA	5 GAL	CTN.	2-3'	3-4'	FULL
1	TM	Taxus x media 'Densiformis'	DENSE SPREADING YEW	1 GAL	CTN.	3'-4'	7'	TRIMMED
PER	ENNI	ALS		<b>'</b>				
QTY	SYN	BOTANICAL NAME	COMMON NAME	SIZE	COND.	HEIGHT	WIDTH	COMMENTS
11	NR	Nepeta racemosa 'Walker's Low'	WALKER'S LOW CATMINT	1 GAL	CTN.	2'-2.5'	2.5'-3'	SPACING 36" O.C.
6	FG	Festuca glauca 'Boulder Blue'	BOULER BLUE FESCUE	1 GAL	CTN.	12"	12"	SPACING 10' O.C.
3	CA	Carex applachina	APPALACHIAN SEDGE	1 GAL	CTN.	6-8"	12-18"	SPACING 16" O.C.
16	HH	Hosta 'Halcyon'	PLANTAIN LILY	1 GAL	CTN.	18-24"	30-36"	SPACING 24" O.C.
6	AS	Aurinia saxatilis	BASKET OF GOLD	1 GAL	CTN.	6-12"	12-18"	SPACING 18" O.C.
48	HS	Helictotrichon sempervirens	BLUE OAT GRASS	1 GAL	CTN.	2-3"	2-3"	SPACING 24" O.C.
3	SS	Schizachyrium scoparium 'The Blues'	THE BLUE LITTLE BLUESTEM	1 GAL	CTN.	2-4'	1.5-2'	SPACING 24" O.C.
10	LM	Liriope muscari	MONKEY GRASS	1 GAL	CTN.	12-18"	12-18"	SPACING 18" O.C.
3	MA	Melica altissima 'Red Spire'	RED SPIRE GRASS	1GAL	CTN.	3-4'	2-3'	SPACING 24" O.C.
24	HA	Hakonechloa macra 'Aureola'	JAPANSES FOREST GRASS	1 GAL	CTN.	1-2'	2-4'	SPACING 18" O.C.
GRC	UND	COVER AND FERN						
QTY	SYN	BOTANICAL NAME	COMMON NAME	SIZE	COND.	HEIGHT	WIDTH	COMMENTS
3		Juniperus horizontalis 'Wiktonii"	BLUE RUG CREEPING JUNIPER	5 GAL	CTN.	4-6"	4-6'	SPACING 5' O.C.
17	JPF	Athyrium niponicum	JAPANSES PAINTED FERN	1 GAL	CTN.	12-18"	18-24"	SPACING 12" O.C.

### GENERAL SITE NOTES:

 LOCATIONS, SIZES, AND DEPTHS OF SUBSURFACE UTILITIES ARE BASED ON OUTDATED BLUEPRINTS FROM 1967. CONTRACTOR TO LOCATE ALL UNDERGROUND UTILITIES PRIOR TO THE START OF WORK. CONTRACTOR IS RESPONSIBLE FOR ANY DAMAGE TO EXISTING UTILITIES NOT OUTLINED IN THE SCOPE OF WORK.

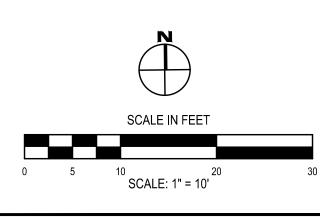

HORSEHEADS, NY 607 - 358 - 1000 ROCHESTER, NY 585 - 327 - 7949 TOWANDA, PA 570 - 265 - 4868 BINGHAMTON, NY 607 - 798 - 8081 ALBANY, NY 607 - 798 - 8081 WWW.HUNT-EAS.COM

DRAWN BY:

CHECKED BY:

COURT SITE UPGRADE PROJECT

C5.2

PROJECT NO: 2285-054

PORCH

CONC. WALK

**⋈** 525.64

**⋈** 525.56

DR. SAMUEL McCREE WAY

LANDSCAPE PLAN - EAST

PORCH


CONC. WALK

Q 522.24

**⋈** 522.41

PORCH

·. 目 · 1F524,35 · :

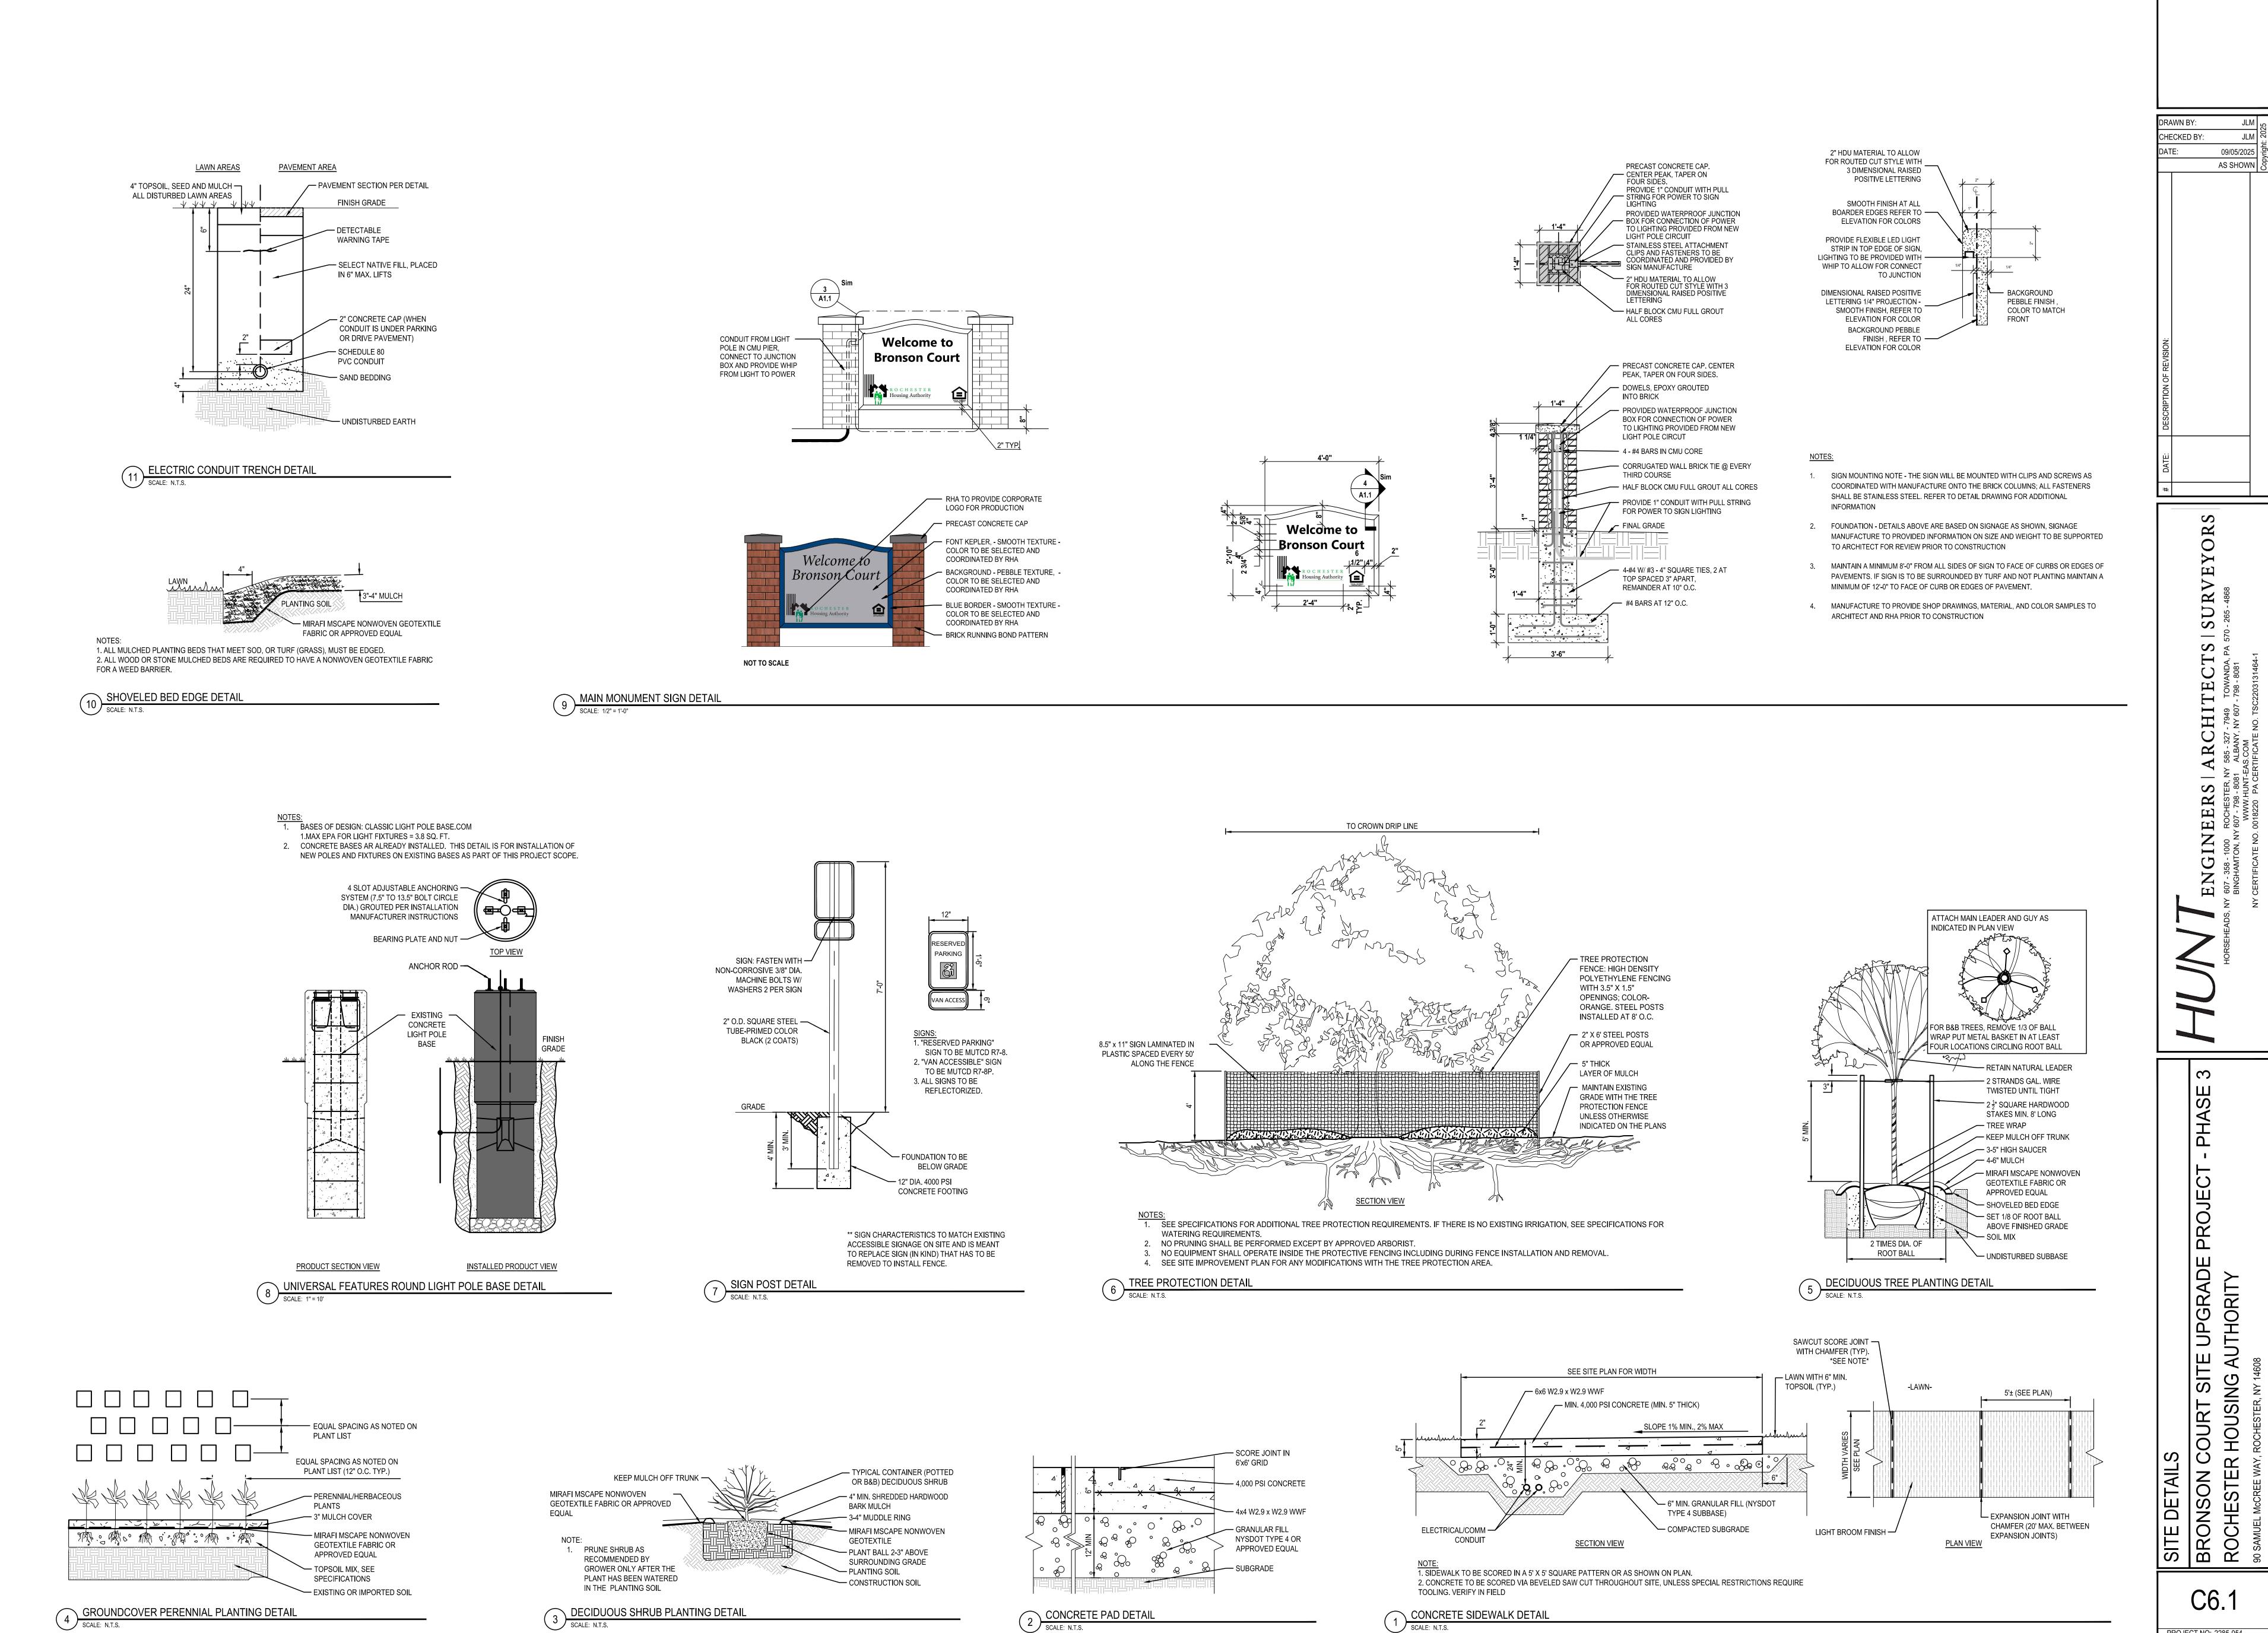

09/05/2025

AS SHOWN

SOURT SI HOUSING

C6.1

PROJECT NO: 2285-054